CULPEPER, VIRGINIA 22701

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REVISIONS:

REV#2 RE-BID 05-08-24

DRAWN: CHECKED: 03-29-23 PROJECT #: 2127

COVER SHEET

CULPEPER COUNTY OPTIONS ADDITION

CULPEPER COUNTY, VIRGINIA

BG 24-2009

NOTICE TO CONTRACTOR & ALL **TRADES**

ALL TRADES SHALL BE RESPONSIBLE FOR THE CONTENTS CONTAINED HEREIN. AND FOR THE INFORMATION REPRESENTED ON ALL SHEETS. THESE CONSTRUCTION DOCUMENTS HAVE BEEN TOOL FOR THE CONSTRUCTION OF THIS PROJECT. NO SINGLE DRAWING WILL STAND ALONE, AND AT NO TIME WILL THE ARCHITECT OR OWNER BE RESPONSIBLE FOR ACTIONS TAKEN BY A CONTRACTOR OR SUBCONTRACTOR WHO HAS NOT REVIEWED, AND IS NOT IN POSSESSION OF A FULL WORKING SET OF DOCUMENTS. BE ADVISED, THERE MAY BE NOTES ON A DRAWING FOR ONE SPECIFIC TRADE THAT WILL PERTAIN TO THE WORK OF OTHER TRADES. GENERAL CONTRACTOR IS RESPONSIBLE FOR THE CLEAR COMMUNICATION BETWEEN ALL TRADES, AND THAT ALL WORKERS HAVE ADEQUATELY REVIEWED ALL DRAWINGS AND LOCATED ALL WORK THAT WOULD FALL UNDER THEIR RESPONSIBILITY.

GENERAL NOTES

BEGINNING AFFECTED WORK.

SHEET WHERE SECTION

IS LOCATED

06/A6.01 → SHEET WHERE DETAIL

- DRAWING NUMBER

IS LOCATED

SYMBOL

IS LOCATED

DRAWING NUMBER

REVISION

MATCH LINE

DOOR NUMBER

WINDOW TYPE

KEYED NOTES

ROOM NUMBER

DRAWING NUMBER

BUILDING PERMIT BY GENERAL CONTRACTOR.

CONTRACTOR SHALL BE RESPONSIBLE FOR ALL TEMPORARY SHORING, BRACING & WEATHER PROTECTION.

CONTRACTOR SHALL BE RESPONSIBLE FOR ALL PROTECTION AND BARRICADING OF PUBLIC AREAS AND NEIGHBORING

CONTRACTOR SHALL COMPLY WITH ALL PERTINENT RULES, REGULATIONS, ORDINANCES, AND LAWS MANDATED BY LOCAL, STATE, AND FEDERAL AGENCIES.

PRIOR TO CONSTRUCTION, EXAMINE ALL PROJECT SPECIFICATIONS, DRAWINGS, AND VISIT THE SITE TO DEVELOP A COMPLETE UNDERSTANDING OF THE PROJECT SCOPE, FAILURE TO DO SO SHALL NOT RELIEVE THE CONTRACTOR OF HIS RESPONSIBILITY TO PERFORM ALL WORK REQUIRED FOR A COMPLETE INSTALLATION. UPON REVIEW OF THESE DOCUMENTS, ADVISE THE ARCHITECT IN A TIMELY MANNER OF ANY DISCREPANCIES WHICH WILL EFFECT THE WORK REQUIRED SO THAT THE ARCHITECT MAY PROVIDE DIRECTION PRIOR TO

CODE INFORMATION - (2018 VEBC)

SCOPE OF PROJECT INCLUDES A NEW (1) STORY, 720 SF BUILDING ADDITION FOOTPRINT WITH BASEMENT OR ALTERNATE CRAWL SPACE.

CONSTRUCTION TYPE: 5B, NO SPRINKLER

BUILDING LIMITATIONS (TABLES 504.3, 504.4 & 506.2): 40 FT, 2 STORY, 9,000 SF

PROJECT W/ ADDITION ACTUAL HEIGHT & AREA: 32' GRADE PLANE TO TOP ROOF, (2) STORY, 1,560 SF

506.3 FRONTAGE INCREASE: NOT TAKEN

NON-SEPARATED SINGLE OCCUPANCY

T601 - FIRE RATING FOR BUILDING ELEMENTS: 0 T602 - EXTERIOR WALLS (0) HR. >10' SEPARATION

CHAPTER 8 INTERIOR FINISHES: INTERIOR WALLS, CEILINGS, & FLOORS SHALL COMPLY WITH VCC CHAPTER 8.

CHAPTER 9 FIRE PROTECTION SYSTEMS

AUTOMATIC SPRINKLER SYSTEM [NR] FIRE EXTINGUISHERS - PROVIDE PER 906 & IFC

907.2.2 FIRE ALARM [NR]) MEANS OF EGRESS

004 OCCUPANCY LOADS: SEE FLOOR PLAN FOR INDIVIDUAL

ROOMS. OCCUPANCY SHOWN BELOW IS MAXIMUM COMBINED BY

BASEMENT = 141ST FLOOR = 452ND FLOOR = 8

TOTAL = 67

BUILDING OCCUPANCY = 49

T1020.1 CORRIDORS (0) RATING WHERE OCCUPANT LOAD SERVED IS LESS THAN 30.

CHAPTER 29 MINIMUM PLUMBING FIXTURES BASED ON MAX. OCCUPANCY OF 49 TOTAL BUILDING OCCUPANTS.

	REQUIRED	PROVIDED	
WC	2	2	
LAV	2	2	
DF	1 HI / LOW	1 HI/LOW	
SS	1	1	

ASSUMED MINIMUM SOIL BEARING CAPACITY - 2,000 PSF

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ACOUSTICAL TILE

GPDW - GYPSUM

RIGID INSULATION

WALL BOARD

OOOO BATT INSULATION

GEOTECHNICAL REPORT NOT AVAILABLE.

CODE INFORMATION (CONTINUED)

CHAPTER 17 SPECIAL INSPECTIONS (NOT REQUIRED - 1704 EXCEPTION 2.1)

BUILDING RISK CATEGORY - II (TABLE 1604.5)

1ST FLOOR = 40 PSF 30 PSF

PG = 30 PSF GROUND SNOWCe = 1.0 SNOW EXPOSURE FACTOR Ct = 1.0 THERMAL FACTOR

Is = 1.0 IMPORTANCE FACTOR

Pf = 25 FOR SLOPED ROOFS

Vasd = 89 MPH EXPOSURE B Kd = 0.85Kzt = 1.0

 $GCPI = 0.18 \pm$

ASCE 7-10

Fv = 2.40

LATERAL FORCE RESISTING SYSTEMS USING EQUIVALENT FORCE PROCEDURE

SEISMIC SITE CLASS = D (ASSUMED)

SEISMIC DESIGN CATEGORY = B BASIC STRUCTURAL SYSTEM = BEARING WALL SYSTEM (CONCRETE SHEAR WALLS)

Sd1 = 10.88%G

Ss = 18.0%GSms = 28.8 %G S1 = 6.80%GSm1 = 16.32 %GFa = 1.60Sds = 19.2 % G

CLO.

CMU

CONC.

CONST

DWG

DTL.

E.C.

ELEV.

EQ.

BB

CLOSET

CONCRETE

DRAWING

DETAIL

EXISTING

ELECTRICAL

ELEVATION

EQUIVALENT

EXPANSION

FIBERGLASS

EXTERIOR

CONSTRUCTION

CONCRETE MASONRY UNIT

ELECTRICAL CONTRACTOR

SEE DRAWINGS FOR BUILDING ENVELOPE & STRUCTURAL SYSTEMS & MATERIALS

MEP COORDINATION NOTE

PLUMBING, ELECTRICAL, & HVAC SYSTEMS ARE TO BE CONSTRUCTED AS COMPLETE, COORDINATED DESIGN / BUILD SYSTEMS. AS A MINIMUM THEY SHALL MEET APPLICABLE BUILDING AND LIFE SAFETY CODES UNDER VA USBC 2018 & ANSI A117.1-2009. EACH SYSTEM DESIGNER/INSTALLER MUST COORDINATE WITH THE GENERAL CONTRACTOR AND OTHER PROJECT SUB-CONTRACTORS.

BASE BID

BASE BID WORK INCLUDES ALL WORK NECESSARY TO EXAMINE EXISTING CONDITIONS & PROVIDE DEMOLITION & NEW CONSTRUCTION IN AN OCCUPIED FACILITY AS INDICATED BY THE DESIGN INTENT OF THE CONSTRUCTION DOCUMENTS. MECHANICAL, ELECTRICAL AND PLUMBING SYSTEMS ARE BEING BID AS COMPLETE, COORDINATED DESIGN / BUILD SYSTEMS. BASE BID SHALL INCLUDE DETAILED DESCRIPTIONS OF THE PROPOSED DESIGN / BUILD SYSTEMS TO INCLUDE PROPOSED EQUIPMENT TYPE, SIZE & MANUFACTURER.

BID ALTERNATES

BID DEDUCT ALTERNATE #1:

- PROVIDE COST & TIME DEDUCTION TO PROVIDE ALTERNATE CONDITIONED CRAWL SPACE CONCRETE FOUNDATION WALLS WITH
- 3'-0" x 4'-0" INSULATED EXTERIOR ACCESS DOOR. HVAC UNIT AND DUCTWORK TO BE LOCATED IN CRAWL SPACE.
- PROVIDE MINIMAL CONDITIONING OF CRAWL SPACE
- IF CRAWL SPACE ALTERNATE IS SELECTED, LOCATE NEW 400A PANEL IN ROOM 101. THICKEN WALL AS REQUIRE FOR NEW RECESSED PANEL. CRAWL SPACE GRADE TO BE 4" HIGHER THAN SURROUNDING EXTERIOR GRADE. PROVIDE 4" STONE DUST OR SAND UNDER 10 MIL VAPOR
- BARRIER THAT TURNS UP THE EXTERIOR WALLS WITH ALL EDGES SEALED EXTERIOR CRAWL SPACE WALL INSULATION TO BE R-15 WITH VERTICAL R-10 RIGID INSULATION FROM TOP OF CRAWL SPACE FOOTING TO
- GRADE. MAINTAIN R-19 FIRST FLOOR JOIST INSULATION. PROVIDE CONCRETE STEPS & SIDE WALLS TO EXISTING PAD AND DOOR TO ACCESS EXISTING CELLAR LEVEL.

WORK BY OTHERS

- DATA CABLING, TELEPHONE, SECURITY, CARD READERS & IT RACKS (SEE
- PLANS FOR CONDUIT W/ PULL STRING & EMPTY BOXES) FURNITURE & FREE-STANDING SHELVING NOT INDICATED IN CONTRACT
- ITEMS SPECIFICALLY IDENTIFIED AS "BY OTHERS" OR N.I.C. EXTERIOR AND INTERIOR SIGNAGE EXCEPT AS INDICATED.

THE REACH RANGE REQUIREMENTS FOR PEOPLE WHO USE A AND FACILITY SCALE.

PROJECT CONTACTS

OWNER

COUNTY OF CULPEPER, VIRGINIA PAUL HOWARD 540.727.3409

ARCHITECT

SANDERS ARCHITECTURE, PC **DEX SANDERS** 540.829.2590

CODE MODIFICATIONS

REQUEST TO INSTALL A PLUMBED WATER COOLER DISPENSER MEETING WHEELCHAIR AND STANDING PERSONS TO BETTER COMPLY WITH THE 2018 VIRGINIA PLUMBING CODE SECTION 410 INTENT OF PROVIDING FREE, POTABLE DRINKING WATER FOR THE OPTIONS USE POPULATION

FINISHED FLOOR PLUMBING CONTRACTOR **ABOVE** BRD. PER SQUARE FOOT ACOUSTICAL CEILING TILE FLR. **FLOOR** PER SQUARE INCH **POROUS FILL** COLUMN BUBBLES A.F.F. ABOVE FINISHED FLOOR FND. FOUNDATION PRESSURE TREATED AND GRID LINES ADJ. **ADJUSTABLE** FRMG. FRAMING PERIM. PERIMETER CONCRETE ALT. ALTERNATE FOOT/FEET PLUMB. **PLUMBING** ALUMINUM **FOOTING** ROUGH OPENING RAIN WATER CONDUCTOR CMU - CONCRETE ARCH. ARCHITECTURAL GENERAL CONTRACTOR RWC MASONRY UNIT B.F.F. BELOW FINISHED FLOOR GWB REINF. REINFORCED GYPSUM WALLBOARD **BSMT BASEMENT** GAUGE REQ. REQUIRED GA. BRICK BLOCKING GALV. GALVANIZED RESPONSIBLE MATCH LINE B.O. **BOTTOM OF** HEATING, VENTILATION & AIR RETURN BOT. BOTTOM CONDITIONING ROOM **SQUARE FEET** BD BOARD HARDWARE ELEVATION BLDG BUILDING HDR. HEADER S.S.R STANDING SEAM ROOF INDICATOR HGT. HEIGHT CERAMIC TILE SCHED. **SCHEDULE** FINISHED WOOD CLG. CEILING HORIZ. HORIZANTAL

INSUL

M.C.

MAX.

MIN.

MTI.

O.C.

PLATE

MANUF.

MECH.

STANDARD INSULATION STOR. INTERIOR STORAGE JANITOR TONGUE & GROOVE **TEMPORARY** T.O. LINEAR FOOT TOP OF TYPICAL MECHANICAL CONTRACTOR UNDERGROUND MOISTURE RESISTANT BOARD U.G. U.N.O. **UNLESS NOTED OTHERWISE** MANUFACTURED VINYL WALLCOVERING VWC MAXIMUN MECHANICAL VERT. **VERTICAL** MINIMUM V.C.T. VINYL COMPOSITE TILE MFTAI ON CENTER W/O WITHOUT PAINTED WELDED WIRE FABRIC

DRAWING TITLE

D1.1

\$1.1

S2.1

A2.1

A8.1

CS.01 COVER SHEET CS.02 PROJECT SPECIFICATIONS C1.1 SITE SKETCH DEMOLITION PLANS FOUNDATION / FRAMING PLAN **ROOF FRAMING PLAN & DETAILS** A1.1 BASEMENT & 1ST FLOOR PLAN A1.2 2ND FLOOR PLAN, WALL TYPES & FINISH SCHED ENLARGED PLANS & MILLWORK DETAILS A4.1 EXTERIOR ELEVATIONS A5.1 **BUILDING SECTIONS & DETAILS** A5.2 **BUILDING SECTIONS & DETAILS** DOOR SCHEDULE M1.1 MECHANICAL CONCEPT PLAN FLOOR PLAN - POWER

CEILING / LIGHTING PLAN

DEX A. SANDERS Lic. No. 8814 03-29-23

REV#1 REVIEW 09-19-23

CS.1

2. UNLESS "NO SUBSTITUTIONS" IS SPECIFICALLY INDICATED, IT IS NOT THE INTENT OF THESE SPECIFICATIONS TO EXCLUDE MANUFACTURERS THAT PRODUCE EQUAL PRODUCTS OR SYSTEMS. CONTRACTOR IS ENCOURAGED TO SUBMIT ALTERNATE PRODUCT OR SYSTEM MANUFACTURERS FOR CONSIDERATION BY ARCHITECT PRIOR TO BID / ORDER (SEE PM SECTION 01600).

3. CONTRACTOR SHALL DAILY REMOVE ALL DEBRIS FROM SITE AND KEEP WORK AREA CLEAN. REMOVE EXCESS MATERIALS FROM SITE.

4. SEE THE PROJECT MANUAL FOR ADDITIONAL SPECIFICATIONS AND INFORMATION.

5. FOLLOWING CONTRACT AWARD, SUBMIT PROPOSED COLOR CHARTS & SAMPLES FOR ALL REQUIRED COLOR SELECTIONS TO ARCHITECT FOR SELECTION & SCHEDULE. MANUFACTURER'S PRINTED COLOR CHARTS FOR PAINTED ITEMS OR PHYSICAL SAMPLES ARE REQUIRED. PAGES PRINTED FROM WEBSITES OR LINKS TO WEBSITES ARE NOT ACCEPTABLE.

6. SUBMITTAL INFORMATION REQUIRED FOR ALL SECTIONS NOTED THUS **. EXCEPT FOR SAMPLES, FURNISH SUBMITTALS IN PDF FORMAT. SUBMIT (2) PHYSICAL SAMPLES FOR COLOR SELECTION.

7. U.N.O., CONTRACTOR SHALL MAKE APPLICATION AND OBTAIN ALL PERMITS REQUIRED FOR THE EXECUTION OF THIS WORK. U.N.O. ALL PERMIT FEES WILL BE PAID BY THE CONTRACTOR. SPECIAL INSPECTIONS REQUIRED BY THE CODE SHALL BE PAID FOR BY THE OWNER. THE OWNER WILL PAY FOR ALL OTHER QUALITY CONTROL INSPECTIONS UNLESS INDICATED OTHERWISE IN THE CONTRACT DOCUMENTS AS WELL AS ELECTRIC & GAS UTILITY CONNECTION FEES & TELEPHONE & DATA SERVICE. CONTRACTOR SHALL COORDINATE WITH SERVICES PROVIDED BY OTHERS.

02000 - <u>SITE WORK</u> (SEE SITE PLAN SHEETS)

1. EXCEPT FOR MATERIALS TO BE RE-USED ON SITE SUCH AS TOPSOIL, CLEARED MATERIALS SHALL BECOME CONTRACTOR'S PROPERTY AND SHALL BE REMOVED FROM THE SITE. CONTRACTOR SHALL PROVIDE ADDITIONAL SOIL AND FILL MATERIAL AS NECESSARY TO COMPLETE THE WORK. 2. DO NOT OBSTRUCT EXISTING STREETS, PARKING OR TRAVELWAYS WITHOUT OBTAINING PRIOR PERMISSION FROM THE OWNER. PARKING MUST BE MAINTAINED DURING CONSTRUCTION FOR SCHEDULED ON-SITE OPERATIONS. 3. PROTECT ALL EXISTING SITE IMPROVEMENTS TO REMAIN DURING CONSTRUCTION. RESTORE

DAMAGED IMPROVEMENTS TO THEIR ORIGINAL CONDITION AS ACCEPTABLE TO THE OWNER. THIS SHALL INCLUDE EXISTING PAVING, STRUCTURES, LANDSCAPING AND UTILITY SERVICES. 4. REPLACE ALL EXISTING TREES SCHEDULED TO REMAIN THAT ARE DAMAGED DURING CONSTRUCTION. 5. DO NOT INTERRUPT EXISTING UTILITIES SERVING FACILITIES OCCUPIED BY THE OWNER WITHOUT PRIOR

WRITTEN PERMISSION. CONTRACTOR MUST FURNISH TEMPORARY UTILITY SERVICES IF SERVICE IS INTERRUPTED TO ANY OCCUPIED AREAS - UNLESS DURING SCHEDULED AND APPROVED SERVICE

6. SUBGRADE BACK FILL SOILS SHALL BE CLEAN AND FREE FROM CLAY & SILTY SOILS AND ROCKS LARGER THAN 3" IN ANY DIMENSION, FROZEN MATERIALS, VEGETATION, WASTE AND OTHER DELETERIOUS MATTER. SEE GEOTECH REPORT RECOMMENDATIONS. 7. STRUCTURAL FILL AND DRAINAGE FILL TO BE #57 STONE OR AS INDICATED IN THE GEOTECHNICAL

8. EXCESS FILL MAY NOT BE SPREAD AND SEEDED ON SITE IN A LOCATION AS ALLOWED AND DIRECTED

BY OWNER. 9. BEDDING FILL TO BE CRUSHED STONE OR GRAVEL WITH 100% PASSING A 1-INCH SIEVE. 10. PROVIDE DETECTABLE WARNING TAPE WITH METAL CORE INSCRIBED WITH DESCRIPTION OF THE

UTILITY 1'-0" MINIMUM ABOVE ALL UNDERGROUND UTILITIES. 11. PROVIDE ALL EROSION AND SEDIMENT CONTROL MEASURES REQUIRED BY THE COUNTY AND STATE 12. EXCAVATE TO SUBGRADE ELEVATIONS REGARDLESS OF THE CHARACTER OF SURFACE OR SUBSURFACE CONDITIONS ENCOUNTERED INCLUDING ROCK, SOIL MATERIALS OR OTHER OBSTRUCTIONS. IF EXCAVATED MATERIALS INTENDED FOR BACKFILL INCLUDE UNSATISFACTORY SOIL MATERIALS AND ROCK - REPLACE WITH SATISFACTORY MATERIALS. **SEE BID FORM FOR ROCK REMOVAL UNIT COST.**

13. EXCAVATE TRENCHES 6 INCHES DEEPER THAN BOTTOM OF PIPE IN ROCK AND 4 INCHES DEEPER ELSEWHERE TO ALLOW FOR BEDDING COURSE. 14. RE-CONSTRUCT SUBGRADES DAMAGED BY FREEZING TEMPERATURES OR WATER, ETC. 15. COMPACTION: PLACE FILL MATERIALS IN LAYERS NOT MORE THAN 8 INCHES AND COMPACT AS

UNDER STRUCTURES - ENGINEERED FILL COMPACTED TO 95% MAXIMUM DRY DENSITY AT OPTIMUM MOISTURE (ASTM D-698)

UNDER WALKS & PAVEMENTS - 95% UNDER LAWNS - 85% 16. OWNER MAY ENGAGE AN INDEPENDENT GEOTECHNICAL TESTING AGENCY TO TEST AND INSPECT

EACH LAYER OF SUBGRADE FILL. WHEN REPORTS INDICATE THAT THE SPECIFIED DEGREE OF COMPACTION IS NOT ACHIEVED, RECOMPACT AND RETEST UNTIL COMPACTION IS ACHIEVED. 17. WHERE SETTLING OCCURS, REMOVE FINISHED SURFACE AND REPAIR TO NEW CONDITION. 18. SEE THE ATTACHED SOILS REPORT INCLUDED IN THE PROJECT MANUAL AND FOLLOW ALL RECOMMENDATIONS OF THE REPORT.

19. CONTRACTOR IS RESPONSIBLE FOR ALL SURVEY, BENCHMARKS AND STAKEOUT REQUIRED FOR THIS

1. CONTRACTOR SHALL EXTEND AND COMPLETE BUILDING UTITLITY SERVICES IN COORDINATION WITH WORK PERFORMED BY OTHERS. 2. PROTECT ALL EXIST. SERVICES IN PLACE.

3. CONTRACTOR SHALL CAREFULY EXAMINE THE SITE TO DETERMINE EXISTING CONDITIONS AND FULL EXTENT OF WORK REQUIRED TO EXTEND ALL UTILITIES TO BUILDING. UTILITY COSTS & PERMIT FEES NOT SPECIFICALLY EXCLUDED ARE A PART OF THIS WORK 4. AT PRE-CONSTRUCTION MEETING, CONTRACTOR SHALL PRESENT THE OWNER WITH A SCHEDULE FOR

HAVING THE OWNER PROVIDED UTILITIES COMPLETE. 5. CONTRACTOR SHALL PROVIDE AND PAY FOR ANY TEMPORARY UTILITY SERVICES REQUIRED FOR CONSTRUCTION PRIOR TO FINAL UTILITY INSTALLATION (I.E. TEMP. H20 & ELEC.).

1. COORDINATE SOIL TREATMENT WITH EXCAVATION, FILLING, GRADING AND CONCRETE WORK 2. SPECIAL WARRANTY: WRITTEN WARRANTY, SIGNED BY APPLICATOR AND CONTRACTOR CERTIFYING THAT TERMITE CONTROL WORK WILL PREVENT INFESTATION OF SUBTERRANEAN TERMITES FOR (3) YEARS FROM DATE OF SUBSTANTIAL COMPLETION.

3. PROVIDE AN EPA - REGISTERED TERMITICIDE THAT IS NOT HARMFUL TO PLANTS. APPLY AS RECOMMENDED BY THE PRODUCT'S EPA-REGISTERED LABEL.

4. POST WARNING SIGNS IN THE APPLICATION AREA. 5. RE-APPLY SOIL TREATMENT TO AREAS SUBSEQUENTLY DISTURBED BY CONSTRUCTION ACTIVITIES.

6. APPLY TO AREAS UNDER SLABS ON GRADE AND FOUNDATIONS AND MASONRY VOIDS.

FOLLOWS OR AS DIRECTED BY THE GEOTECHNICAL ENGINEER:

1. PROTECT EXISTING TREES TO REMAIN. PROVIDE FENCING OUT TO DRIP LINE OF EXISTING TREES TO REMAIN SURROUNDING THE CONSTRUCTION AREA. 2. LANDSCAPING IS LIMITED TO FINE GRADING AND RE-SEEDING LAWN AREAS DISTURBED BY

CONSTRUCTION. 3. ALL FERTILIZER SHALL CONFORM TO APPLICABLE STATE FERTILIZER LAWS. NO BIO-SOLIDS SHALL BE

BROUGHT ON SITE. 4. ALL PLANTING SOIL SHALL BE CLEAN, FRIABLE AND WELL DRAINED.

03300 CAST-IN-PLACE CONCRETE **

SEE STRUCTURAL SHEETS FOR ADDITIONAL INFORMATION. FOLLOW STRUCTURAL SHEET SPECIFICATIONS WHERE STRUCTURAL SHEET REQUIREMENTS ARE MORE STRINGENT.

1. FLOOR SLABS, WALLS & FOOTINGS - 3,500 PSI WITH FIBER MESH FOR FINISHED INTERIOR SLABS. ALL CONCRETE EXPOSED TO EXTERIOR TO BE AIR ENTRAINED 6% AT ± 1.5% AT POINT OF PLACEMENT.

2. CONCRETE WORK SHALL CONFORM TO THE CURRENT VERSION OF: ACI 318-14 - BUILDING CODE REQUIREMENTS FOR STRUCTURAL CONCRETE ACI 301-10 - SPECIFICATIONS FOR STRUCTURAL CONCRETE

3. PROVIDE STANDARD BAR CHAIRS & AND SPACERS AS REQUIRED FOR 3" COVER AT FOUNDATIONS AND 2" COVER AT FORMED WALLS AND ELEVATED SLABS. SUPPORT WIRE MESH W/ CONT. SLAB BOLSTERS @ 4'-0" OC MAX.

4. CONTRACTOR SHALL CAREFULLY MONITOR CONCRETE PLACEMENT ACTIVITIES TO MINIMIZE SPILLAGE & CLEAN BOTH INTERIOR AND EXTERIOR AREAS WHERE CONCRETE SPLATTERS OR DRIPS 5. NO DUMPING OF EXCESS CONCRETE OR TRUCK CLEAN UP TO OCCUR ON SITE UNLESS APPROVED

IN ADVANCE BY OWNER. 6. REINFORCING BARS: ASTM A615, GRADE 60. FLAT SHEET WELDED WIRE FABRIC: ASTM A1064. MINIMUM LAP SLICE TO BE 48 BAR DIAMETERS. 7. WATERSTOPS: RUBBER OR PVC

8. VAPOR BARRIER: 10 MIL MINIMUM POLYETHYLENE SHEETS - SEAL ALL EDGES & TURN UP WALL AT SLAB AROUND PERIMETER. PROVIDE UNDER ALL INTERIOR SLABS

9. JOINT FILLER STRIPS: ASPHALT-SATURATED CELLULOSIC FIBER.

04200 UNIT MASONRY (NOT USED)

SPECIFICATIONS (CONT.)

ALL STRUCTURAL STEEL WORK SHALL CONFORM TO THE REQUIREMENTS OF AISC 360-10" SPECIFICATION FOR STRUCTURAL STEEL BUILDINGS". IF CONNECTIONS ARE NOT SHOWN ON DRAWINGS, FABRICATOR SHALL DESIGN CONNECTIONS FOR BEAM MEMBER UNIFORMLY LOADED TO CAPACITY.

ASTM A36 (ANGLE, CHANNELS, PLATES & OTHER STRUCTURAL SHAPES) Fy = 36 KSI EXTERIOR STEEL EXPOSED TO THE WEATHER TO BE HOT DIPPED GALVANIZED.

05500 METAL FABRICATIONS **

ALL EXTERIOR METAL FABRICATIONS INCLUDING EXTERIOR RAILS TO BE GALVANIZED FINISHED. RAILS TO BE FULLY WELDED WITH ALL WELDS GROUND SMOOTH & NO VISIBLE PITS OR OPENINGS. FABRICATE COMPLETE RAIL SECTIONS TO BE INSTALLED IN AS LONG A LENGTH AS POSSIBLE. 3. FIELD MEASURE AS-BUILT CONDITION & SUBMIT SHOP DRAWINGS FOR ALL METAL FABRICATIONS.

UNLESS NOTED OTHERWISE.

COATING (I.E. SIMPSON ZMAX G185).

CONFORM TO NDS-2018 "NATIONAL DESIGN SPECIFICATIONS" FOR WOOD CONSTRUCTION. PROVIDE BLOCKING FOR ALL ITEMS MOUNTED TO FRAMING.

WHEN FRAMING IS COMPLETED, BUT BEFORE INSULATION, CONTRACTOR SHALL MEET WITH ARCHITECT TO REVIEW FRAMING AND BLOCKING.

SUBMIT ENGINEERED & FIRE TREATED WOOD PRODUCTS FOR REVIEW. ALL WOOD FRAMING WALLS AND MEMBERS SHALL BE ERECTED STRAIGHT, PLUMB AND LEVEL.

WALLS THAT ARE BOWED OR CROOKED SHALL BE STRAIGHTENED 7. ALL MISC. BLOCKING MEMBERS FOR ROOFING SYSTEMS OR IN CONTACT WITH EXTERIOR WALLS,

SLABS OR MASONRY TO BE PRESERVATIVE TREATED. 8. EXPOSED EXTERIOR TRIM & PANELS TO BE FACTORY PRIMED OR PRE-FINISHED WHITE BORAL OR FIBER-CEMENT EQ. TO JAMES HARDIE SMOOTH FINISH.

9. ALL ROUGH CARPENTRY SHALL CONFORM TO THE REQUIREMENTS OF THE

NDS-2018 "NATIONAL DESIGN SPECIFICATIONS (NDS) FOR WOOD CONSTRUCTION WITH 2015

ALL EXTERIOR LOAD BEARING STUD WALLS ARE DESIGNED AS PERFORATED SHEAR WALLS BY THE ASD METHOD IN ACCORDANCE WITH NDS - SPECIAL DESIGN PROVISIONS FOR WIND & SEISMIC.

PROVIDE NO. 2 SOUTHERN PINE OR EQ. WITH 19% MAXIMUM MOISTURE CONTENT FOR ALL FRAMING LUMBER INCLUDING, LINTELS, JOISTS, RAFTERS, AND BEAMS UNLESS NOTED OTHERWISE. WALL STUDS AND PLATES MAY BE S-P-F No. 1 / 2 U.N.O. ON PROJECT SPECIFIC DETAILS AND NOTES.

PROVIDE MICROLLAM VENEER LUMBER (LVL) MIN. 2.0E, PARALLAM PARALLEL STRAND LUMBER (PSL), AND TIMBERSTRAND LUMBER (LSL) MIN. 1.8E, MANUFACTURED BY TRUS JOIST (OR APPROVED EQUAL).

ALL FRAMING CONNECTIONS NOT SPECIFICALLY INDICATED ON THESE CONSTRUCTION DOCUMENTS SHALL COMPLY WITH THE MINIMUMS ESTABLISHED BY TABLE 2304.9.1 OF THE VUSBC.

ALL NAILED CONNECTIONS (OF TWO 2x MEMBERS) SPECIFICALLY INDICATED ON THESE CONSTRUCTION DOCUMENTS ARE ASSUMED TO BE DONE USING A MINIMUM NAIL SIZE OF 0.131" DIAMETER x 3" LONG

ALL LIGHT GAGE STEEL PRE-FORMED CONNECTORS SHALL BE INSTALLED USING THE NUMBER OF NAILS AND NAIL TYPE LISTED FOR THAT CONNECTOR BY THE MANUFACTURER IN THEIR PUBLISHED LITERATURE. ALL NAILS LISTED AS 1 1/2" LONG SHALL BE MADE BY THE MANUFACTURER OF THAT CONNECTOR. HANGERS OR CONNECTORS USED WITH PRESSURE TREATED LUMBER SHALL HAVE G185 MINIMUM ZINC

PROVIDE A MINIMUM OF THREE INCHES OF BEARING FOR ENGINEERED LUMBER BEAMS, UNLESS OTHERWISE NOTED.

ALL BEAMS SHALL BE LATERALLY SUPPORTED BY BLOCKING OR OTHER MEANS AT ALL POINTS OF

NAILS INSTALLED PARALLEL TO THE GLUE LINES ON THE NARROW FACE OF ENGINEERED LUMBER BEAMS SHALL NOT BE SPACED CLOSER THAN FOUR INCHES FOR 10d COMMON NAILS AND THREE INCHES FOR

DO NOT DRILL, NOTCH, CUT (EXCEPT TO LENGTH), OR ALTER ENGINEERED LUMBER BEAMS OR JOISTS WITHOUT WRITTEN APPROVAL OF FABRICATOR AND REVIEW BY STRUCTURAL ENGINEER.

10. ALL POST-INSTALLED ANCHORS (IN CONCRETE OR CMU) ARE TO BE INSTALLED IN STRICT CONFORMANCE WITH THE MANUFACTURER'S RECOMMENDATIONS (INCLUDING BUT NOT LIMITED TO DRILL BIT SIZE, PROPER CLEANING OF HOLES, INSTALLATION TORQUE, AND TEMPERATURE CONSTRAINTS).

WHEN A SPECIFIC PRODUCT AND MANUFACTURER IS REFERENCED IN THE CONTRACT DOCUMENTS, THAT SPECIFIC PRODUCT SHALL BE USED UNLESS AN ALTERNATE PRODUCT IS APPROVED IN WRITING BY THE ARCHITECT OR STRUCTURAL ENGINEER OF RECORD PRIOR

FASTENERS GENERICALLY REFERRED TO AS "SCREW ANCHOR" ON THE DRAWINGS SHALL

1. TITEN HD BY SIMPSON STRONG-TIE ANCHOR SYSTEMS

2. KWIK HUS-EZ BY HILTI

FOR THESE SCREW ANCHORS LISTED, USE STANDARD ANSI DRILL BIT (NO SPECIAL BIT REQUIRED). PROVIDE HOLES IN STEEL MEMBERS 1/8" LARGER THAN NOMINAL DIAMETER

CHEMICAL ADHESIVE ANCHORING SYSTEMS USED IN CONCRETE GENERICALLY REFERRED TO AS "ADHESIVE ANCHORS" SHALL BE ONE OF:

1. SET-XP BY SIMPSON STRONG TIE

2. AT-XP BY SIMPSON STRONG TIE

3. HIT-RE 500-V3 BY HILTI

5. HIT-HY 200 BY HILTI

THREADED ROD ANCHORS USED WITH THESE SYSTEMS SHALL BE PROVIDED BY THE ADHESIVE MANUFACTURER AND HAVE A MINIMUM STEEL STRENGTH OF Fy = 36 KSI UNLESS NOTED OTHERWISE. REINFORCING STEEL USED WITH THESE SYSTEMS SHALL

COMPLY WITH ASTM A615 GRADE 60.. ANY PRODUCTS SUBMITTED AS A REQUEST FOR SUBSTITUTION SHALL BE COMPLIANT WITH ACI 318-11 APPENDIX D AND APPROVED FOR USE IN CRACKED CONCRETE. FASTENERS GENERICALLY REFERRED TO AS "EXPANSION ANCHORS" OR "WEDGE

ANCHORS" SHALL BE ONE OF: 1. KWIK BOLT TZ BY HILTI

2. STRONG-BOLT 2 BY SIMPSON STRONG TIE ANCHOR SYSTEMS

3. POWER- STUD + SD2 BY POWERS FASTENERS

FASTENERS GENERICALLY REFERRED TO AS "CONCRETE/MASONRY SCREWS" SHALL BE

1. KWIK-CON II + BY HILTI

2. TITEN BY SIMPSON STRONG TIE ANCHOR SYSTEMS (DO NOT USE TITEN HD

3. TAPPER + BY POWERS FASTENERS

071400 FOUNDATION DRAINAGE & WATERPROOFING 1. PROTECT ALL WATERPROOFING APPLICATIONS WITH RIGID INSULATION OR PROTECTION BOARD AS RECOMMENDED BY PRODUCT MANUFACTURER.

2. PROVIDE CONTINUOUS STONE & 4" FOUNDATION DRAINAGE TO DAYLIGHT ALONG ALL BELOW GRADE FOUNDATION WALLS.

3. WATERPROOFING TO BE EQUAL TO RUB-R-WALL ELASTOMERIC MEMBRANE (3) LAYERS W/ GEO-WRAP PLASTIC PROTECTION MEMBRANE WHERE EXPOSED TO EARTH AS RECOMMENDED BY SYSTEM MANUFACTURER

SPECIFICATIONS (CONT.)

07210 BUILDING INSULATION

1. PERIMETER FOUNDATION INSULATION TO BE DOW XPS EXTRUDED POLYSTYRENE UNDER SLAB INSULATION. PROVIDE MIN. R-10, 2" x 24" VERTICAL RIGID FOUNDATION INSULATION BELOW EXTERIOR PERIMETER FOUNDATION SLAB WHERE FINISH GRADE IS LESS THAN 2'-0" ABOVE FINISHED

2. SOUND BATTS INSULATION TO BE UN-FACED SOUND ATTENUATION FIBERGLASS BATT INSULATION BY OWENS CORNING IN 3" THICKNESS U.N.O. SOUND BATTS SHALL BE INSTALLED IN ALL INTERIOR WALLS SURROUNDING NEW ENCLOSED SPACES U.N.O.

3. EXTERIOR CAVITY WALL INSULATION AT 2X6 FRAME WALLS TO BE OWENS CORNING UNFACED CONT. R-21 MIN. BATTS U.N.O.

4. ATTIC INSULATION TO BE OWENS CORNING UNFACED BATTS MIN. R-38 U.N.O. 5. FLOOR INSULATION ABOVE BASEMENT TO BE MINIMUM R-21 BATTS. PROVIDE FOIL FACED WHERE

6. BASEMENT WALL INSULATION TO BE MINIMUM R-15 FOIL FACED IF EXPOSED

7. PROVIDE INSULATION MARKED WITH R-VALUE SO INSPECTORS CAN CONFIRM CONFORMANCE WITH CONSTRUCTION DOCUMENTS AND ENERGY CODE.

07400 SIDING PANELS **

1. CEMENT-FIBER TRIM & PANELS TO BE EQUAL TO JAMES HARDIE PRIMED SMOOTH FACED. INSTALL W/ STAINLESS STEEL CONCEALED FASTENERS. EXPOSED & PAINTED TRIM BOARDS TO BE FIBER-CEMENT OR BORAL 1" THICKNESS (NOMINAL 5/4) OR AS INDICATED. SOFFIT PANELS TO BE FIBER CEMENT - VENTED WHERE INDICATED. TRIM TO BE FACTORY PRIMED OR PRE-FINISHED IN COLOR AS SELECTED BY OWNER W/ CUT JOINTS PRIMED & SEALED AS RECOMMENDED BY SIDING MANUFACTURER. CEMPLANK OR NICHIHA ARE ACCEPTABLE ACCEPTABLE EQUAL.

2. SOFFIT PANELS TO BE WHITE VINYL VENTED AT ALL GUTTER EAVES. 3. FOLLOW MANUFACTURE'S INSTALLATION AND FINAL COATING PREPARATION

RECOMMENDATIONS. 4. SEE ELEVATION SHEET FOR EXTERIOR PRODUCT SCHEDULE.

07450 METAL ROOFING **

1. ROOFING TO BE EQUAL TO FABRAL SNAP-ON -SEAM 1" HEIGHT STANDING SEAM W/ CONCEALED CLIP, 24 GA. KYNAR OR HYLAR COATED STEEL PANELS WITH 20 YEAR MIN. WARRANTY ON PRODUCT WEATHERTIGHTNESS & COATING. 16" SEAM SPACING. PROVIDE MATCHING PANEL

FLASHING AND TRIM. 2. INSTALL ON SUBSTRATE RECOMMENDED BY PANEL SYSTEM MANUFACTURER FOR WARRANTY.

3. CONTRACTOR SHALL PROVIDE A ZERO COST TO OWNER (2) YEAR LABOR AND MATERIAL WARRANTY COVERING WEATHER-TIGHTNESS OF ROOFING AND FLASHING FROM DATE OF SUBSTANTIAL COMPLETION.

4. PRE-FINISHED METAL SOFFIT MATERIAL TO BE PRE-FORMED 0.032 MINIMUM THICKNESS ALUMINUM.

07500 COMPOSITION SHINGLES (NOT USED)

1. TYPICAL PRODUCTS SHALL BE DOW CORNING - 790 OR GE SILICONE SILPRUF 2000 WEATHERING

2. EXTERIOR BUILDING MASONRY / CONCRETE CAULKING TO BE PECORA 890 NST WITH CONTINUOUS BACKER ROD. SUBMIT COLOR SAMPLE FROM MANUFACTURER FOR SELECTION TO MATCH BRICK. PREPARE ALL JOINTS AS RECOMMENDED BY THE MANUFACTURER AND PERFORM A FIELD ADHESION TEST PRIOR TO FINAL APPLICATION. APPLY AND TOOL SEALANT TO DEPTH RECOMMENDED BY

3. SEAL ALL LOCATIONS BETWEEN BUILDING AND WALKS WITH PECORA SILICONE TRAFFIC SEALANT -TRAFFIC 301NS IN COLOR TO MATCH WALK. CUT OFF REMAINING EXPANSION JOINT FILLER (EPS) BACK TO RECOMMENDED DEPTH BEFORE APPLYING SEALANT.

079500 EXPANSION JOINT COVERS (NOT USED)

SEE SHEET A4.2 FOR WINDOWS & STOREFRONT ENTRANCES.

08110 STEEL DOOR & FRAMES (SUBMITTAL REQUIRED)**

1. STEEL FRAMES TO BE SHOP PRIMED 16 GA. STEEL WITH HARDWARE FACTORY CUT & FULLY WELDED SEAMS WITH ALL WELDS GROUND SMOOTH, DRYWALL RETURN ALL FRAMES. PROVIDE (3) JAMB ANCHORS PER JAMB & ANCHOR TO FLOOR. PROVIDE CONT. HEADER ABOVE DOORS.

2. FIELD VERIFY WALL THICKNESS AND MASONRY OPENINGS.

3. INSTALL DOOR & FRAME SQUARE, PLUMB & LEVEL SO DOORS OPEN AND CLOSE WITH EASE. 4. STEEL DOORS TO BE 16 GA, FULLY WELDED & INSULATED, REINFORCED FOR CLOSERS & OTHER

08200 WOOD DOORS (SUBMITTAL REQUIRED)** 1. WOOD DOORS: EQ. TO MASONITE GRAHAM SOLID CORE WOOD PRIMED PAINT DOORS. INTERIOR DOORS MAY BE PROVIDED AS FACTORY STYLE AND RAIL OR WITH FACTORY APPLIED MOULDINGS. ALL DOORS TO HAVE SOLID ENGINEERED LUMBER STAVED CORE UNLESS A MINERAL CORE IS REQUIRED FOR FIRE-RATING. PARTICLE CORE DOORS ARE NOT ACCEPTABLE. ALL DOORS TO BE REINFORCED FOR CLOSERS. FINISH: PRIMED PAINT FINISH. ALGOMA IS AN ACCEPTABLE

2. DOOR JAMBS TO BE SET PLUMB AND LEVEL SO DOOR HAS AN EVEN REVEAL AND OPENS AND CLOSES WITHOUT BINDING OR SCRAPING THE FLOOR. DOORS SHALL LATCH WITHOUT SLAMMING

OR WITH CLOSER FORCE IF EQUIPPED WITH A CLOSER. 3. PROVIDE MATCHING TRIM AT GLASS LITES.

09200 GYPSUM BOARD ASSEMBLIES 1. PROVIDE COMPLETE GYPSUM BOARD ASSEMBLIES AS INDICATED FOR NEW WORK. INSTALL GYPSUM BOARD PANELS VERTICALLY ALONG STUD IN CONTINUOUS PANELS TO DECREASE BUTT

JOINTS WHERE POSSIBLE. PROVIDE MR BOARD IN NON-FIRE RATED WET WALL LOCATIONS. 2. ACOUSTICAL INTERIOR WALLS INDICATED ARE TO BE INSTALLED W/ ALL EDGE CONDITIONS AND PENETRATIONS SEALED TO MAINTAIN ACOUSTICAL NRC RATING. ALL OFFICE, CLASSROOM &

CORRIDOR WALLS REQUIRE ACOUSTIC SEPARATION. 3. FINISH GYPSUM BOARD SO THAT SEAMS & SCREW LOCATIONS ARE NOT VISIBLE AFTER PAINT FINISH

4. WHERE GYPSUM BOARD MEETS CMU WALLS, FRAMES OR OTHER STRUCTURE, PROVIDE A CONT. METAL J-BEAD OR ZIP BEAD EDGE WITH A FLEXIBLE SEALANT FILLER.

5. A LEVEL 4 FINISH SHALL BE REQUIRED IN ALL SPACES. AREAS OF ABOVE CEILINGS AND OTHER CONCEALED AREAS TO HAVE TAPED SEAMS ONLY.

6. CROOKED CORNERS OR WALLS WILL BE REQUIRED TO BE STRAIGHTENED. 7. PROVIDE CONTROL JOINTS WHERE INDICATED. REVIEW ANY ADDITIONAL CONTROL JOINT LOCATIONS RECOMMENDED BY THE GYPSUM BOARD SYSTEM INSTALLER WITH THE ARCHITECT

09300 CERAMIC TILE & STONE (NOT USED)

DURING INTERIOR ROUGH-IN.

09510 ACOUSTICAL TILE CEILING (NOT USED)

09650 RESILIENT FLOORING ** (SUBMIT PROPOSED COLOR SAMPLES) 1. 🖁 x 4" RUBBER COVE BASE BY JOHNSON RUBBER CO. INSTALL SO ALL SEAMS ARE TIGHT & FLUSH WITH WALL. RUN AS LONG A RUN AS POSSIBLE AVOIDING SHORT CUT PIECES, NO RUNS LESS THAN

1'-4" LONG. SUBMIT COLOR FOR SELECTION. 2. LVT-1: INTERFACE NATURAL WOODGRAINS LEVEL SET. SUBMIT PATTERN FOR SELECTION.

3. PROVIDE ADHESIVE RECOMMENDED BY INSTALLER AND MANUFACTURER FOR MEASURED FLOOR MOISTURE CONTENT. DO NOT BEGIN FLOOR INSTALLATION UNTIL FLOOR MOISTURE CONTENT & UNDERLAYMENT IS ACCEPTABLE TO INSTALLER AND MANUFACTURER FOR A (1) YEAR MIN. FULL LABOR AND MATERIAL WARRANTY AGAINST MATERIAL DEFECTS AND BUBBLES / ADHESION.

09660 <u>CARPET</u> ** (NOT USED)

1. PREPARE ALL SURFACES FOR COATINGS & APPLY COATINGS AS RECOMMENDED BY THE MFG. SPECIFICATIONS BELOW BASED ON SHERWIN-WILLIAMS. NOTE THAT EXPOSED ALUM., BRASS, CHROME, STAINLESS STEEL, ETC. TO BE LEFT UNFINSHED. DO NOT PAINT OVER TAGS & LABELS.

2. NO SPRAY APPLICATION OF PAINT WITHOUT PRIOR APPROVAL FROM OWNER. IF SPRAY APPLICATION IS USED, TURN OFF HVAC SYSTEM & PROTECT EQUIPMENT & ADJACENT SURFACES 3. EXTENT OF COATING IN CONTRACT INCLUDES: EXTERIOR SURFACES THAT ARE NOT PRE-FINISHED.

PAINT INTERIOR FERROUS METALS - METAL DOORS, FRAMES & RAILS, ALL EXPOSED GYPSUM

DRYWALL SURFACES, AS WELL AS EXPOSED DUCTWORK, PIPING & CONDUIT. 4. PRIOR TO APPLICATION OF ANY COATING, PAINTING CONTRACTOR WILL EXAMINE THE SUBSTRATE TO BE COATED. APPLICATION OF PAINT DEMONSTRATES PAINTING CONTRACTOR'S ACCEPTANCE

5. PAINT CONTRACT SHALL INCLUDE UP TO (2) PAINT WALL COLORS PER SPACE - SEE FINISH PLANS 6. APPLY COATING TO FINISH THICKNESS RECOMMENDED BY COATING MFG. OWNER SHALL DOCUMENT PRIME COAT APPLICATION. NO FINISH COAT APPLICATION SHALL START UNTIL PRIME **SPECIFICATIONS (CONT.)**

PAINTING SCHEDULE:

EXTERIOR FERROUS METAL: The dry film thickness of the paint at any point shall not be less than the following: for the primer 1.5 mils; for the three coat paint system 3.5 mils. In the event the required paint film thickness is not

achieved as specified, additional coats shall be applied until the required thickness is obtained.

EXTERIOR STEEL GALVANIZED & NON-GALVANIZED (Exception: All exterior galvanized rails around basement stair to be left with exposed galvanized finish). Prepare per workmanship above.

1st Coat: SW Pro-Cryl Universal Acrylic Primer B66-1310 Series 2nd Coat: SW Pro Industrial Acrylic Coating, Semi-gloss B66-650 or 600 Series.

3rd Coat: SW Pro Industrial Acrylic Coating, Semi-gloss B66-650 or 600 Series EXTERIOR CONCRETE

1st Coat: S-W Loxon XP WATERPROOFING MASONRY COATING

2nd Coat: S-W Loxon XP WATERPROOFING MASONRY COATING

EXTERIOR FIBER-CEMENT (FACTORY PRIMED) Field Prime: PrimePlus 1st Coat: SW Duration Exterior ACRYLIC Latex Satin 2nd Coat: SW Duration Exterior ACRYLIC Latex Satin

INTERIOR GYPSUM DRYWALL:

1st Coat: SW Pro-Mar 200 Zero VOC Interior Latex Primer 2nd Coat: SW Pro-Mar 200HP Zero VOC Acrylic 3rd Coat: SW Pro-Mar 200HP Zero VOC Acrylic

NOTE: EGGSHELL TYPICAL FOR WALLS; APPLY SEMI-GLOSS FINISH TO TOILET, KITCHEN & JANITOR CLOSET

INTERIOR FERROUS METALS:

Group A: All interior metal not pre-finished and in particular: door jambs, steel doors and frames, etc. Primer: Factory primer or SW Pro-Cryl Universal Acrylic Primer 2nd Coat: SW Pro-Mar 200HP Zero VOC Acrylic

GALVANIZED METAL: same as for ferrous metals above.

3rd Coat: SW Pro-Mar 200HP Zero VOC Acrylic

PAINTED WOOD WORK: 1st Coat: SW Pro-Mar 200 Zero VOC Interior Latex Primer 2nd Coat: SW Pro-Mar 200HP Zero VOC Acrylic 3rd Coat: SW Pro-Mar 200HP Zero VOC Acrylic

INTERIOR CONCRETE FLOOR (Addition basement level, stairs & equipment platform) 1st Coat: H&C ClariShield Water-Based Natural Look Clear Sealer 2nd Coat: H&C ClariShield Water-Based Natural Look Clear Sealer

1. PROVIDE BEST MANUFACTURING SYSTEM HC 300 ADA SYSTEM. COLOR AS SELECTED BY ARCHITECT. 2. PROVIDE (1) HC 300 6"x8" AT EACH TOILET DOOR MOUNTED AT 60" A.F.F TO CENTER. SIGNS SHOULD

INDICATE "UNI-SEX" AS WELL AS HC ACCESSIBILITY. 3. ADDITIONAL INTERIOR SIGNAGE BY OWNER.

10800 TOILET ACCESSORIES ** 1. SEE SHEET A1.2 FOR TOILET ACCESSORIES

11130 <u>AUDIOVISUAL EQUIPMENT</u> 1. U.N.O. ALL AUDIO VISUAL EQUIPMENT WILL BE FURNISHED AND INSTALLED BY OWNER. AT PRE-CONSTRUCTION MEETING CONTRACTOR TO IDENTIFY SCHEDULING REQUIREMENTS AND ALERT OWNER OF TIMING OF ANY A/V INSTALLATIONS. THE OWNER WILL PROVIDE ALL DATA CABLING,

2. PROVIDE EMPTY DATA BOXES AND CONDUIT TO ABOVE OR BELOW CEILING AS INDICATED.

12000 FURNISHINGS 1. ALL FURNISHINGS ARE BY OTHERS.

SUBMIT ALL EQUIPMENT & FIXTURES FOR REVIEW

TELEPHONE SERVICE AND EQUIPMENT.

13850 FIRE ALARM & DETECTION (NOT USED)

15000 MECHANICAL ** PLUMBING AND MECHANICAL SYSTEMS ARE BID AS DESIGN / BUILD SYSTEMS.

COORDINATION WITH ELECTRICAL AND OTHER BUILDING TRADES IS A PART OF THIS WORK.

ELECTRICAL SYSTEMS ARE BID AS DESIGN / BUILD SYSTEMS SUBMIT ALL PANELS, DEVICES & LIGHTING FOR REVIEW

SUBMITTAL SCHEDULE SUBMIT SHOP DRAWINGS & PRODUCT INFORMATION IN PDF FORMAT EXCEPT FOR PHYSICAL SAMPLES. SUBMIT (3) PHYSICAL SAMPLES - (1) ARCHITECT, (1) OWNER & (1) RETURN TO CONTRACTOR.

COORDINATION WITH MECHANICAL & PLUMBING AND OTHER BUILDING TRADES IS A PART OF THIS

COMBINE MULTIPLE PDF DOCUMENTS INTO ONE PDF DOCUMENT FOR REVIEW FOR EACH DIVISION.

07400

08110

09900

TERMITE CONTROL 02361 03300 CAST-IN-PLACE CONCRETE 05500 EXTERIOR RAILS

SIDING & PANELS

07450 ROOFING MATERIALS (ROOF COLOR SAMPLE SAMPLE) 08000 **WINDOWS**

WOOD DOORS 08710 DOOR HARDWARE SCHEDULE RESILIENT FLOORING (COLOR SAMPLES)

PAINTING (COLOR SAMPLES)

DESIGN FOR EACH SYSTEM.

STEEL DOORS & FRAMES

10425 INTERIOR SIGNAGE (COLOR CHART) TOILET ACCESSORIES & PARTITIONS


SUBMIT MECHANICAL, ELECTRICAL & PLUMBING SYSTEM SUBMITTALS REQUIRED TO EVALUATE

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16125 RACCOON FORD RD CULPEPER, VIRGINIA 22701 (v)540-829-2590

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CHECKED: 03-29-23 PROJECT #: 2127

REV#1 REVIEW 09-19-23

REV#2 RE-BID 05-08-24

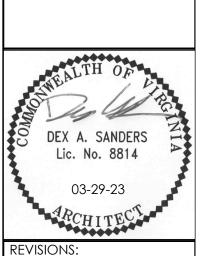PROJECT **SPECIFICATIONS**

ADMINISTRATIVE SITE DATA (ZONING ORDINANCE 20-5-2)

(35) FEET; ACCESSORY STRUCTURE SIDE AND REAR YARD (10) FEET

BOARD OF SUPERVISORS

4. LOT SIZE: 1.00 ACRE

NOT BE MARKED.

SITE PLAN GENERAL NOTES

FOR SITE OPERATIONS.

PRE-CONSTRUCTION CONDITION.

2. PLAN NORTH & DATE OF PLAN IDENTIFIED 3. EXISTING ZONING: R-2 RESIDENTIAL

ARE SERVED BY PUBLIC WATER AND SEWER.

9. NO STREAMS OR BODIES OF WATER ARE IDENTIFIED

11. NO GRAVES ARE IDENTIFIED ON THE PROPERTY

10. STREETS & RIGHT OF WAY IDENTIFIED

7. ENTRANCE AND TRAVELWAYS INDICATED ON THE PLAN.

1. T.M. 50-11C OWNER: CULPEPER COUNTY SCHOOL BOARD; DEVELOPER: CULPEPER COUNTY

5. LOT SETBACKS: STREET (50) FEET FROM STREET RIGHT OF WAY; SIDE YARD (20) FEET; REAR YARD

6. NO WELLS OR SANITARY DISPOSAL SYSTEMS WERE LOCATED ON THE PROPERTY. STRUCTURES

8. EXISTING PARKING INDICATED ON PLAN: (9) SPACES PROVIDED; SPACES ARE PROPOSED TO

1. SITE DATA USED ON PLAN TAKEN FROM DIGITAL SURVEY INFORMATION PROVIDED BY RICHARD

4. PRESERVE & PROTECT ALL EXISTING STRUCTURES, PAVING, WALKS AND LAWN AREAS TO REMAIN.

2. CONTRACTOR SHALL FIELD VERIFY OBSERVABLE EXISTING CONDITIONS PRIOR TO BID. 3. ALL UNDER-GROUND UTILITY LOCATIONS ARE NOT IDENTIFIED. CALL MISS-UTILITY PRIOR TO EXCAVATION. EXCEPT FOR SCHEDULED INTERRUPTIONS, MAINTAIN EXISTING UTILITY SERVICE

REPAIR EXISTING CONDITIONS DAMAGED BY CONSTRUCTION ACTIVITIES TO

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16125 RACCOON FORD RD CULPEPER, VIRGINIA 22701 (v)540-829-2590

OPTIONS COUNTY

CULPEPER

REVISIONS: REV#1 REVIEW 09-19-23


REV#2 RE-BID 05-08-24

DRAWN: CHECKED: SCALE: 03-29-23 PROJECT #: 2127

SITE SKETCH

C1.1

NOTE: THIS PLAN WAS APPROVED BY CULPEPER COUNTY ZONING ON 02/01/2023.

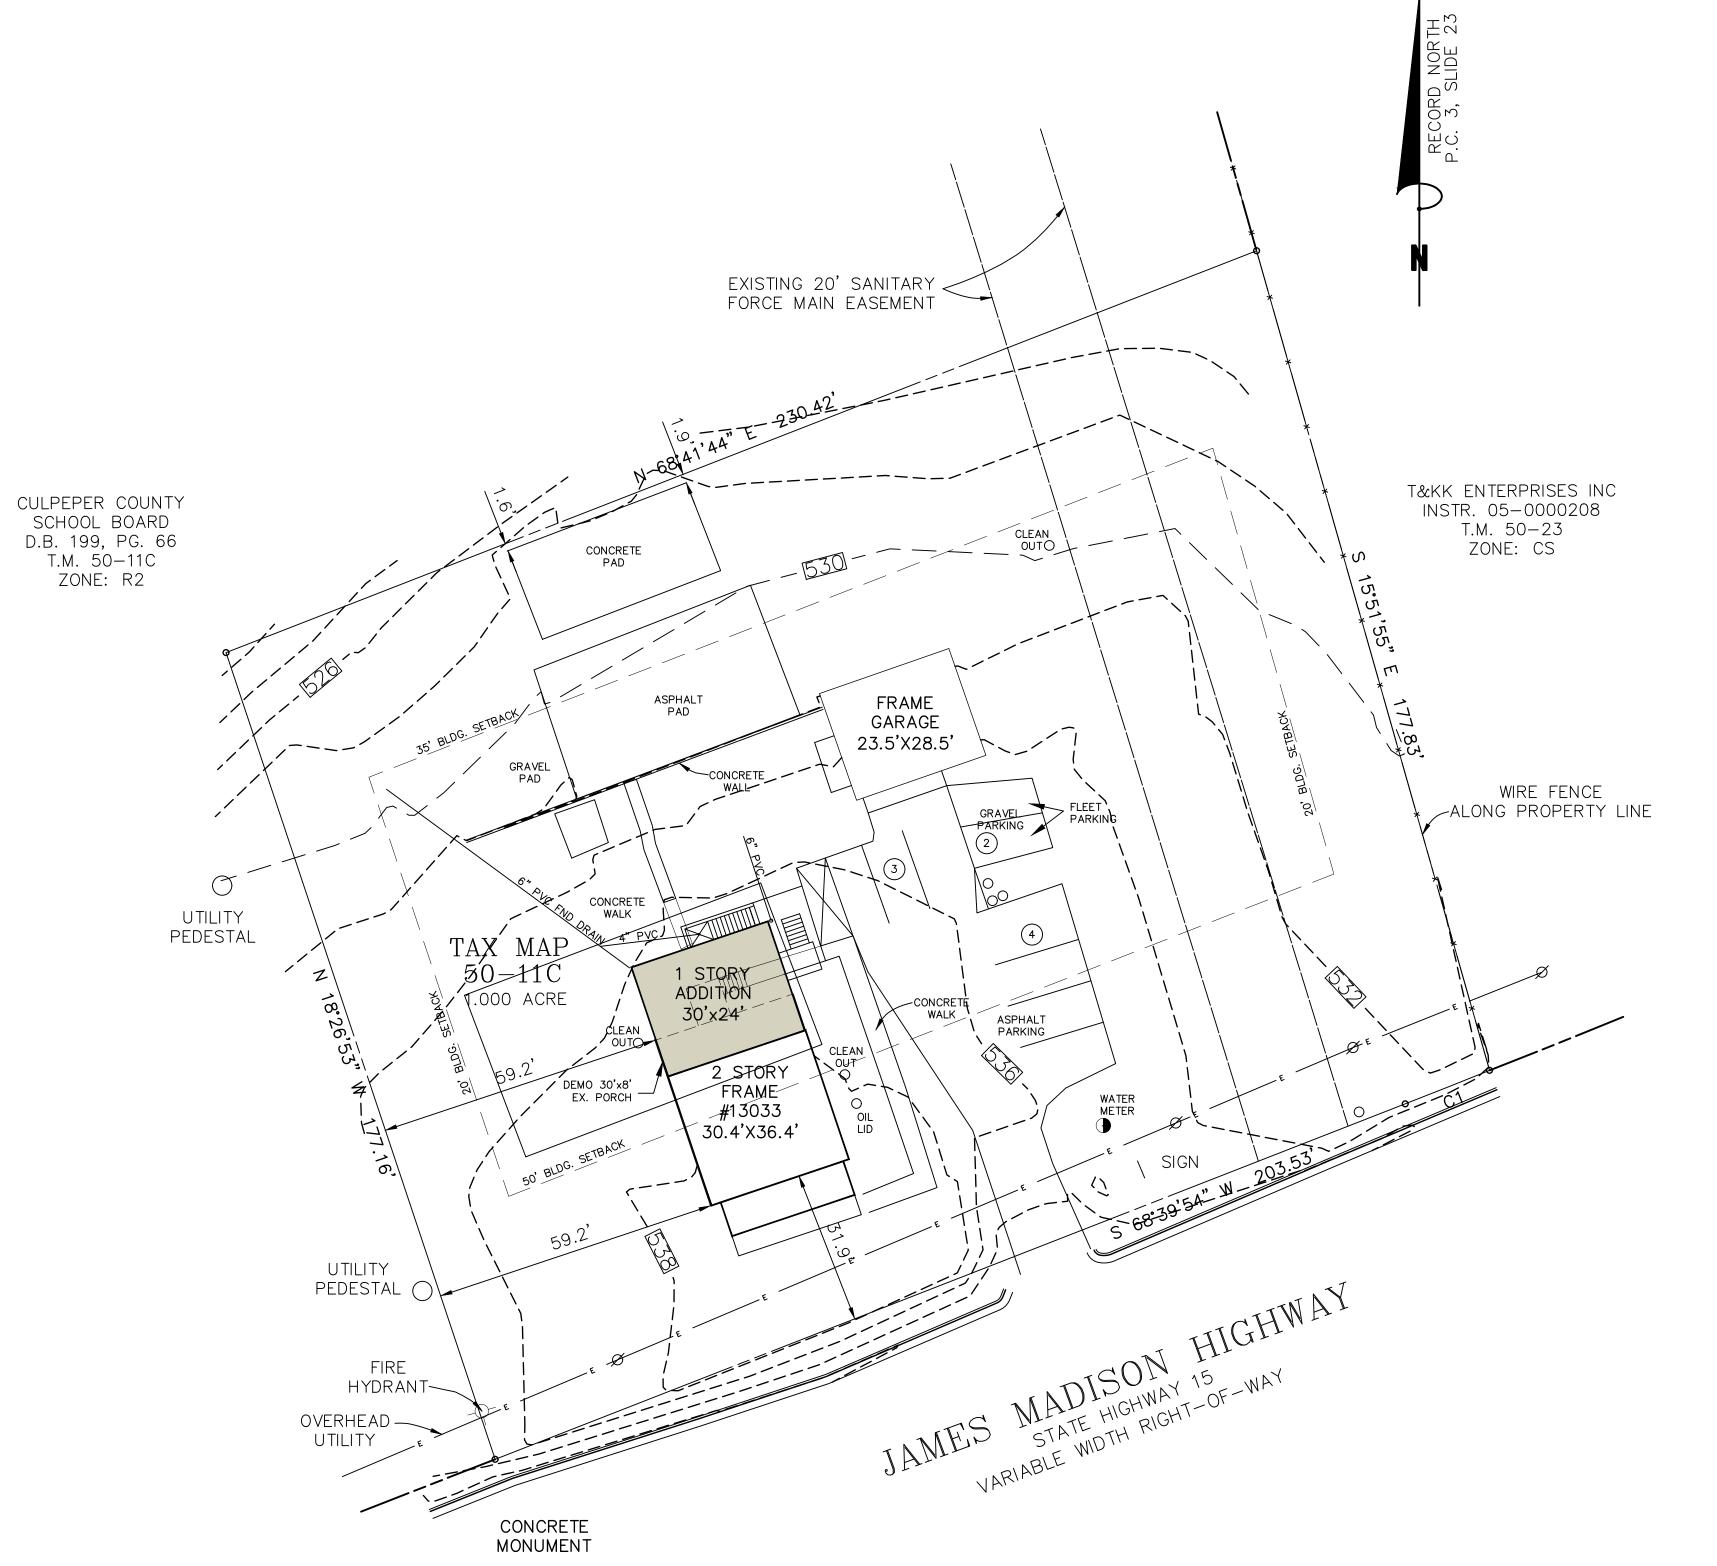

CURVE TABLE

CURVE	RADIUS	ARC LENGTH	CHORD LENGTH	CHORD BEARING	DELTA ANGLE
C1	1722.95	18.89'	18.89'	S 68°21'03" W	0°37'41"

SURVEYOR'S CERTIFICATE

THIS TOPOGRAPHIC SURVEY ON THE LANDS OF CULPEPER COUNTY SCHOOL BOARD WAS COMPLETED UNDER THE DIRECT AND RESPONSIBLE CHARGE OF RICHARD BURKE LS, FROM AN ACTUAL GROUND SURVEY MADE UNDER MY SUPERVISION; THAT THE ORIGINAL DATA WAS OBTAINED ON DECEMBER 21, 2022; AND THAT DIGITAL GEOSPATIAL INCLUDING METADATA MEETS MINIMUM ACCURACY STANDARDS UNLESS OTHERWISE NOTED.

HORIZONTAL DATAM = RECORD NORTH, VERTICAL DATUM = ASSUMED

ADMINISTRATIVE SITE PLAN SCALE: 1" = 20'


revisions:


REV#1 REVIEW 09-19-23 REV#2 RE-BID 05-08-24

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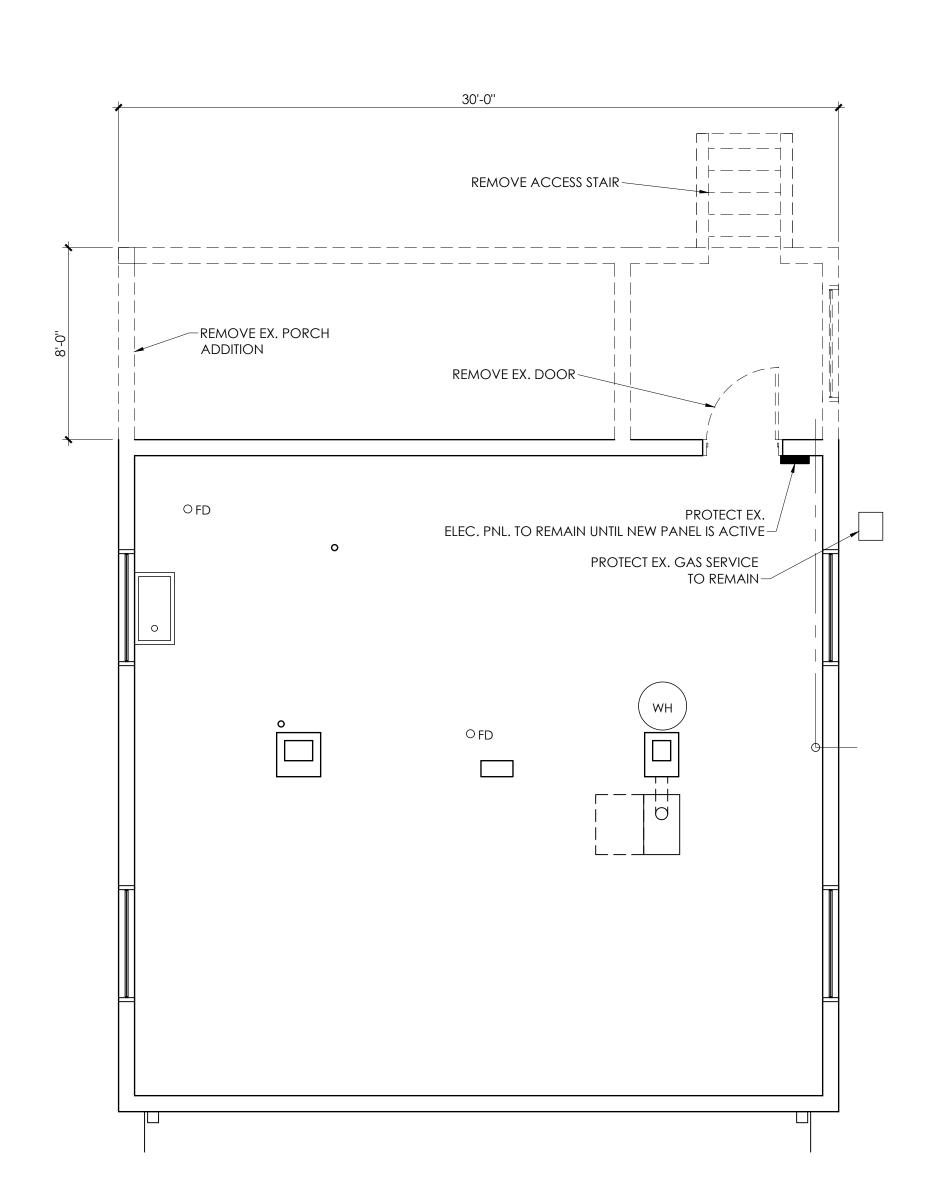
> DEMOLITION PLAN

> > D1.1



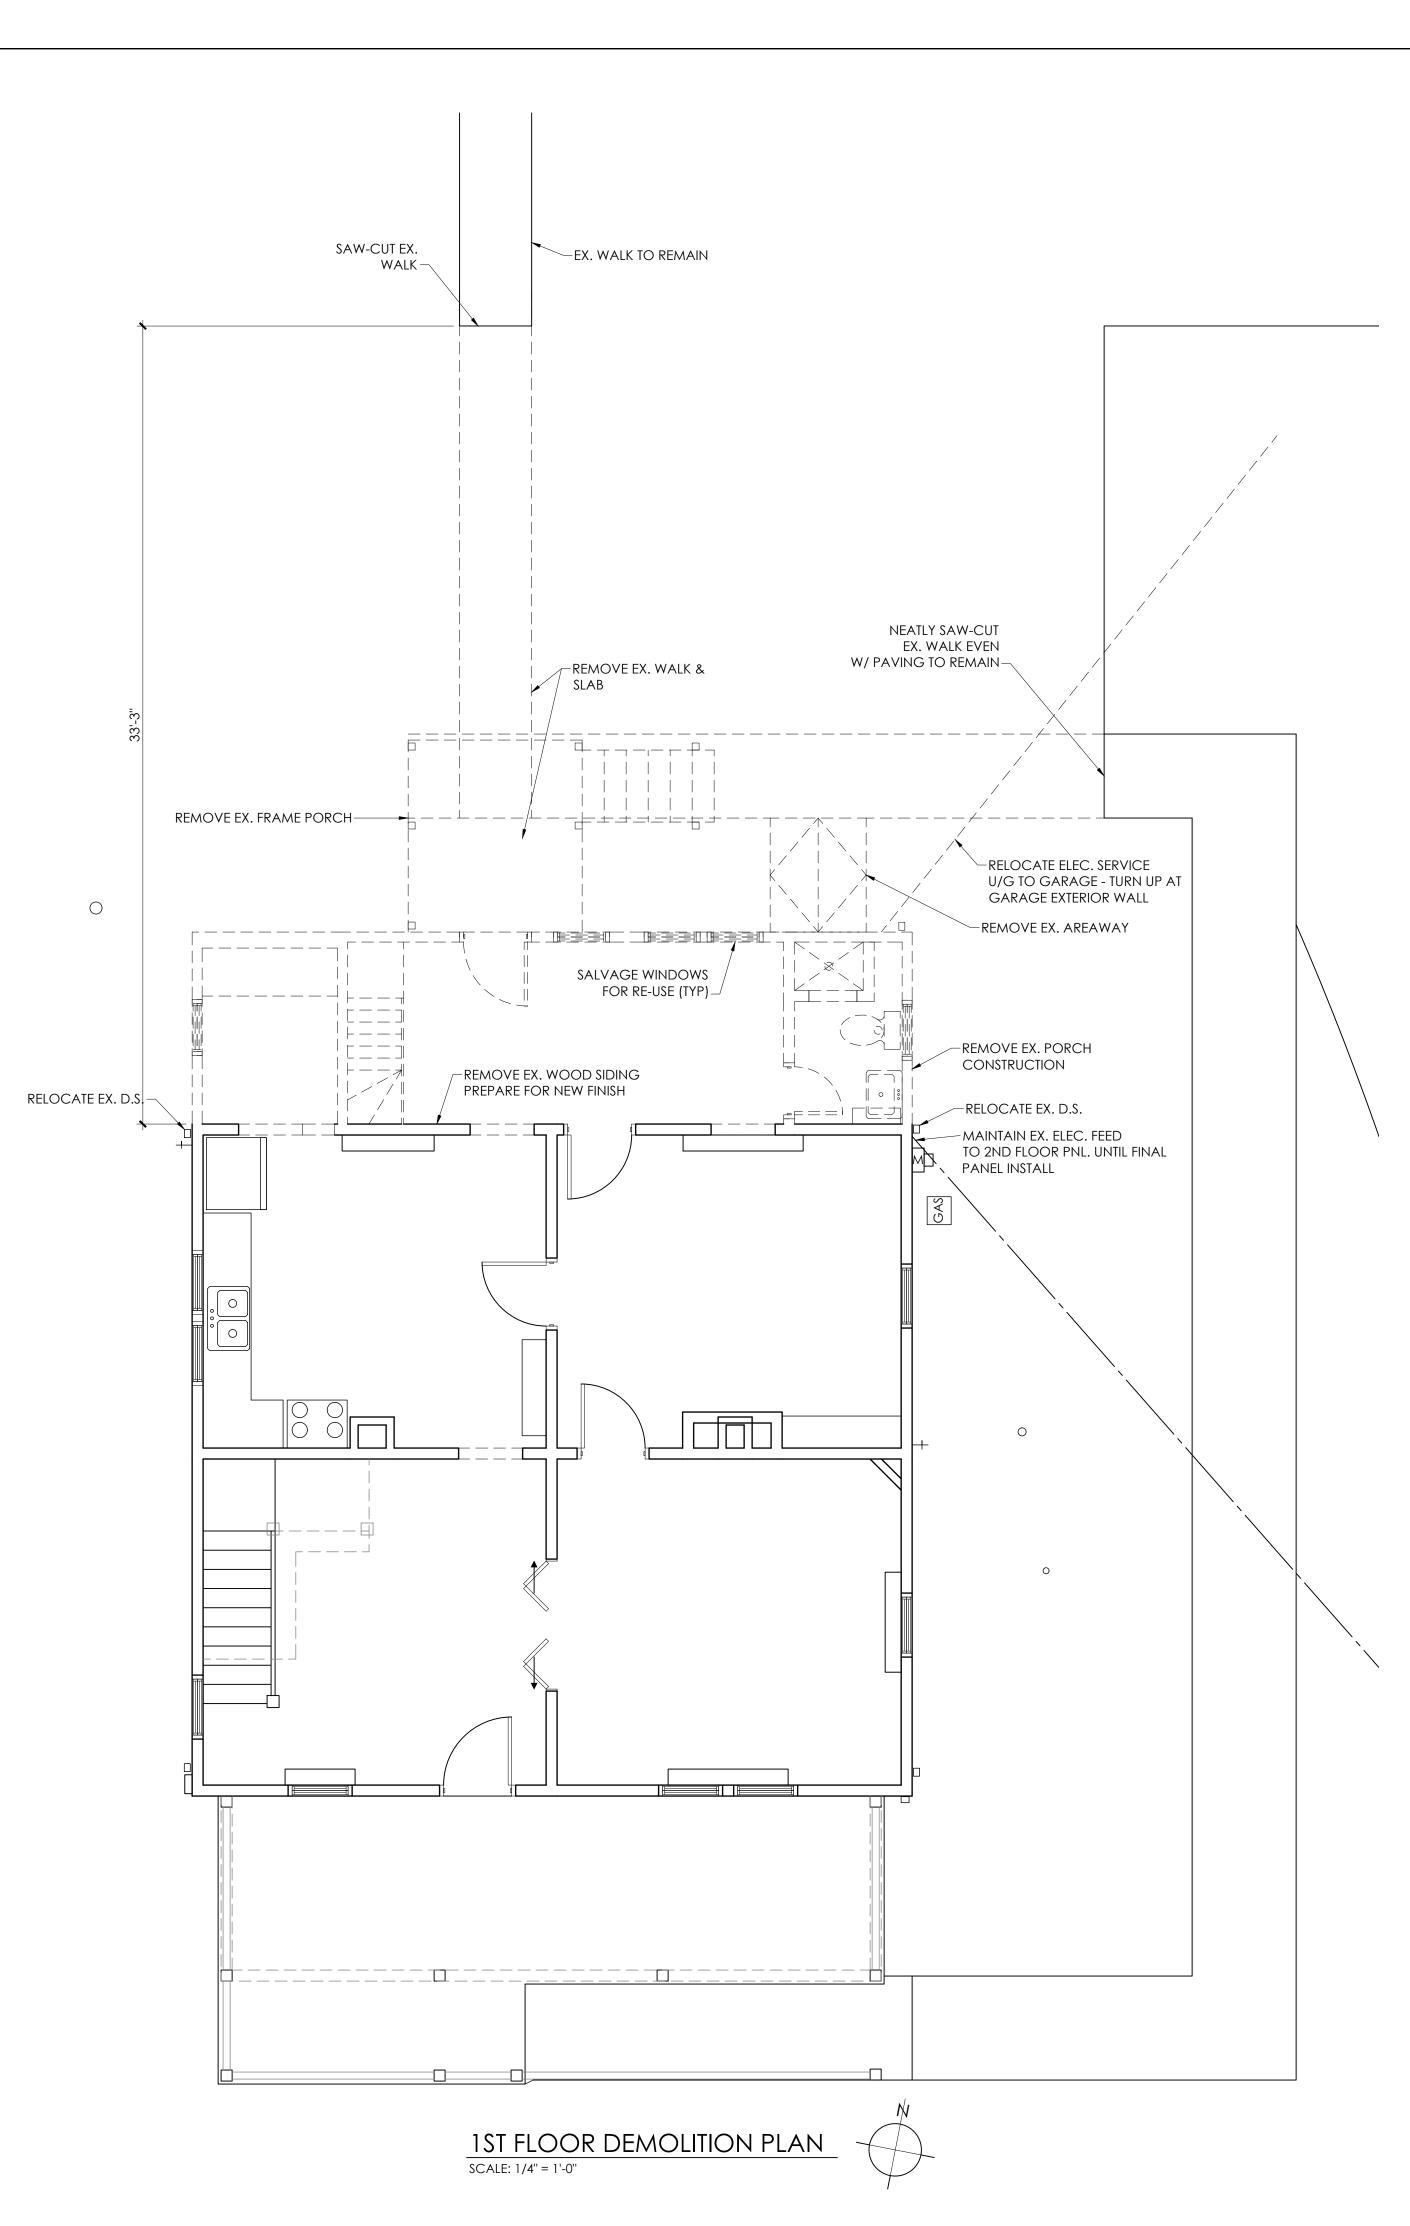

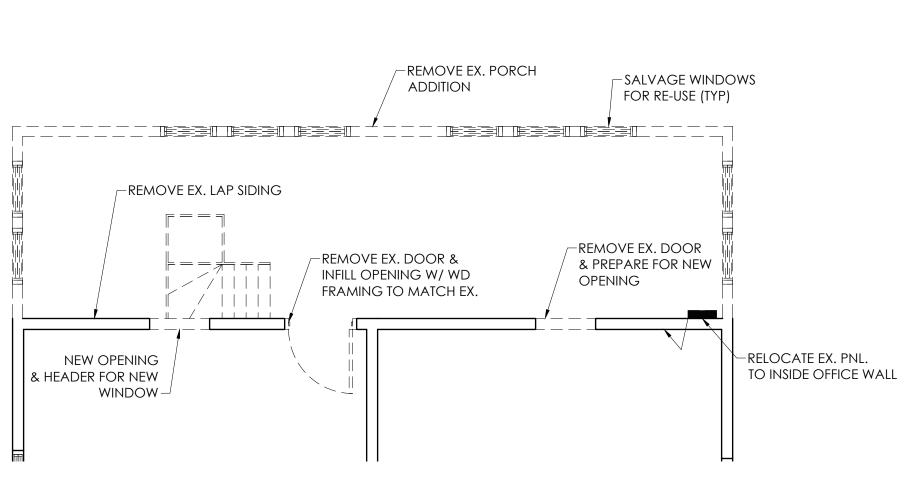2ND FLOOR DEMOLITION PLAN SCALE: 1/4" = 1'-0"



BASEMENT DEMOLITION PLAN SCALE: 1/4" = 1'-0"

GENERAL DEMOLITION NOTES

SEE PROJECT MANUAL SECTION 01732 SELECTIVE DEMOLITION FOR ADDITIONAL INFORMATION & REQUIREMENTS.

THE INTENT OF DEMOLITION ACTIVITIES GENERALLY IS TO PREPARE FOR NEW FINISHED WORK AND TO RETURN EXISTING DISTURBED AREAS TO A CONDITION TO MATCH EXISTING ADJACENT FINISHES. IT IS IMPERATIVE THAT THE CONTRACTOR AND ANY SUB- CONTRACTORS INVOLVED IN THE WORK EXAMINE THE SITE PRIOR TO SUBMITTING A BID TO IDENTIFY MISC. AREAS OF REPAIR NECESSARY TO COMPLETE THE WORK. REQUESTS FOR CHANGES WILL NOT BE GRANTED TO PERFORM DEMOLITION WORK REQUIRED TO COMPLETE THE PROJECT THAT IS VISIBLE AT THE TIME BIDS ARE SUBMITTED.

1. WHERE FLOOR, WALLS OR CEILING ARE REMOVED, REPAIR EXISTING ADJACENT FLOOR, BASE, WALLS & CEILING TO MATCH ADJACENT FINISHES UNLESS OTHERWISE SCHEDULED. PROVIDE NEW COVER PLATES WHERE PLATES ARE MISSING OR DAMAGED. UNLESS OTHERWISE NOTED, TOUCH UP REPAINTING SHALL COVER ENTIRE WALL SURFACE AFFECTED BY DEMOLITION. RE-PAINT BOTH SIDES OF DOORS & FRAMES IN AREAS SCHEDULED FOR NEW FINISHES.

2. ALL DEMOLITION ACTIVITIES SHALL BE PERFORMED IN FULL COOPERATION AND COORDINATION W/ OWNER. COORDINATE ALL LOSS OR REDUCTION OF EGRESS ELEMENTS OR ELECTRICAL OR COMMUNICATIONS SYSTEMS WITH OWNER. FOR INTERIOR REMODELING, ERECT DUST BARRIERS & NEGATIVE PRESSURE ENCLOSURES AROUND ENTIRE NEW CONSTRUCTION AREA TO PROTECT ADJACENT SPACES FROM DUST AND DEBRIS. **CONTRACTOR SHALL MAINTAIN DUST BARRIER** INTEGRITY TO OWNER'S SATISFACTION AT ALL TIMES UNTIL SUBSTANTIAL **COMPLETION.** VERIFY AT PRE-CONSTRUCTION MEETING ACCESS TO WORK AREA AND EXTENT OF WORK TO BE PERFORMED AFTER HOURS.

3. WHERE EXIST. ITEMS ARE RELOCATED, REPAIR DAMAGES TO ORIGINAL LOCATION AND PROVIDE HANGERS, SUPPORTS, WIRING, CONDUIT, ETC. NECESSARY FOR THE RELOCATION.

4. PROTECT EXISTING STRUCTURE FROM DAMAGE & WATER & MOISTURE INFILTRATION DURING CONSTRUCTION ACTIVITIES. EXTREME CARE MUST BE TAKEN NOT TO DAMAGE OR DISTURB EXISTING EQUIPMENT WHILE PERFORMING WORK. **DO NOT TURN OFF BREAKERS OR VALVES WITHOUT** OWNER'S PERMISSION.

5. DURING REGULAR BUSINESS HOURS, MAINTAIN REQUIRED EXITS FROM BUILDING TO THE SATISFACTION OF THE BUILDING OFFICIAL.

6. U.N.O. EXISTING VALVES, ELECTRICAL RECEPTACLES, SWITCHES & EQUIPMENT SERVICING EXISTING FACILITY TO REMAIN. CONTRACTOR SHALL COORDINATE ALL POWER OR FIRE ALARM SYSTEM INTERRUPTIONS WITH OWNER'S REPRESENTATIVE.

7. WHERE NEW PENETRATIONS ARE MADE THRU EXISTING EXTERIOR WALLS OR ITEMS ARE REMOVED CREATING HOLES - SEAL FOR INSULATED & WEATHER-TIGHT ENCLOSURE.

8. IT IS THE INTENTION OF THESE BID DOCUMENTS TO IDENTIFY THE GENERAL DESIGN INTENT OF THE DEMOLITION AND REMODELING WORK NECESSARY FOR THE PERFORMANCE OF THIS REMODELING PROJECT. CONTRACTOR & SUB-CONTRACTOS <u>MUST</u> FIELD VERIFY EXISTING MISC. CONDUIT, PIPING, EQUIPMENT AND OTHER ITEMS THAT WILL NEED TO BE REMOVED AND OR RELOCATED. THIS WILL REQUIRE VISITING THE SITE PRIOR TO SUBMITTING BIDS TO UNDERSTAND EXISTING CONDITIONS FOR ITEMS TO BE REMOVED AND OR RELOCATED. THE OWNER'S CONSTRUCTION REPRESENTATIVE(S) SHOULD BE CONTACTED PRIOR TO BIDS SO ANY QUESTIONS MAY BE ANSWERED BEFORE BIDS ARE SUBMITTED.

9. FINISHED FLOOR SPACE IS EXTREMELY VALUABLE TO THE OWNER. CONTRACTOR TO BOX TIGHTLY AROUND ALL EXPOSED PIPING & CONDUIT WITH SCHEDULED FINISH. CONTRACTOR SHALL BOX IN AROUND CONDUITS, MISC. DUCTS & OTHER EXPOSED PIPING WITH GWB ON METAL FRAMING.

10. REPORT ANY DAMAGE TO EXISTING EQUIPMENT OR STRUCTURE TO OWNER AT THE TIME OF DAMAGE - EVEN IF THE DAMAGE IS PROMPTLY #5 @ 12" OC

VERTICAL BARS

>8'-0" TO 9'-0"

 UNBALANCED FILL HEIGHT
 REINFORCING

 < 5'-0"</td>
 #4 @ 48" OC

 >5'-0" TO 6'-0"
 #5 @ 24 OC

 >6'-0" TO 7'-0"
 #5 @ 20" OC

 >7'-0" TO 8'-0"
 #5 @ 16" OC


HORIZONTAL BARS (TYP) #4 @ 32" W/ CONT. #4 WITHIN 4" OF TOP OF WALL.

PROVIDE VERT. BARS WITHIN 4" EACH SIDE OF WINDOW & DOOR OPENINGS.

BARS SHALL BE LOCATED 2" FROM INTERIOR WALL FACE. DOWEL BARS 6" MIN. INTO FOOTING.


ALL FOUNDATION WALLS SHALL HAVE CONTINUOUS 12" WIDE #57 GRAVEL AGAINST WALL & 4" DRAIN TO DAYLIGHT WRAPPED BY FILTER CLOTH.

FIELD VERIFY FINAL GRADES BEFORE PLACING REINFORCING.

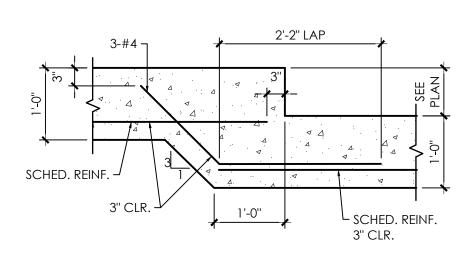


FOOTING STEP DETAIL

SCALE: 3/4" = 1'-0"

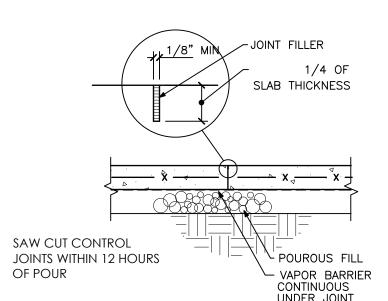

SAW CUT JOINT - STOP WWF EACH SIDE CONTROL JOINT DETAIL

SCALE: 3/4" = 1'-0"

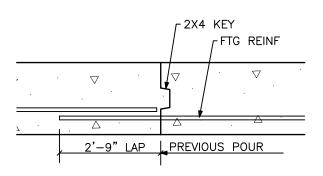

FOOTING CONSTRUCTION JOINT

SCALE: 3/4" = 1'-0"

FOUNDATION EXCAVATION NOTES:

1. WHERE SOIL IS OVER EXCAVATED UNDER FOOTINGS BELOW DESIGN ELEVATIONS FOR CONTRACTOR CONVIENINCE OR DUE TO TYPE OF EQUIPMENT UTILIZED, CONTRACTOR TO PLACE CONCRETE FLOWABLE FILL TO BRING BOTTOM OF FOOTING UP TO DESIGN ELEVATION


2. CONTRACTOR TO PROVIDE ALL SHORING AND BARRICADES NECESSARY TO CREATE SAFE WORKING CONDITIONS WITHIN AND AROUND EXCAVATIONS.

3. WHERE VERTICAL REINFORCING BARS ARE EXPOSED FOR AN EXTENDED PERIOD BELOW WALKING SURFACES, PROVIDE PROTECTION AGAINST FALL IMPALEMENT.

FOUNDATION NOTES


1. ALL FOOTINGS ARE DESIGNED TO REST ON UNDISTRUBED NATURAL SOIL OR CONTROLLED COMPACTED FILL HAVING A MINIMUM SAFE BEARING CAPACITY OF 2,000 PSF. ELEVATIONS SHOWN ARE FOR BIDDING PURPOSES ONLY. IF SOIL OF THE DESIGNED CAPACITY IS NOT ENCOUNTERED AT THE ELEVATIONS SHOWN, THE FOOTING SHALL BE LOWERED OR THE SIZE AND REINFORCEMENT ADJUSTED AS DIRECTED BY THE ARCHITECT. OBTAIN INSPECTION AND APPROVAL OF FINAL FOOTING EXCAVATIONS BY THE OWNER'S REGISTERED GEOTECHNICAL PROFESSIONAL ENGINEER BEFORE PLACING FOUNDATION CONCRETE.


- 2. FIELD VERIFY ALL EXISTING GRADES. ADJUST FOOTING ELEVATION TO FINISHED GRADES.
- 3. BOTTOM OF ALL FOOTINGS SHALL BE A MIN. OF 1'-0" BELOW EXIST. GRADES AND 2'-6" MIN. BELOW FINAL GRADES.
- 4. UNLESS OTHERWISE INDICATED, WALL FOOTINGS SHALL BE CENTERED ON WALLS; COLUMN FOOTINGS SHALL BE CENTERED ON COL. PEDESTALS.
- 5. STEPS IN WALL FOOTINGS SHALL HAVE A MIN. SPACING OF DOUBLE THE CHANGE IN ELEVATION.
- 6. PROTECT ALL FOOTINGS FROM PHYSICAL DAMAGE OR REDUCED STRENGTH CAUSED BY FROST HEAVE OR FREEZING ACTIONS.

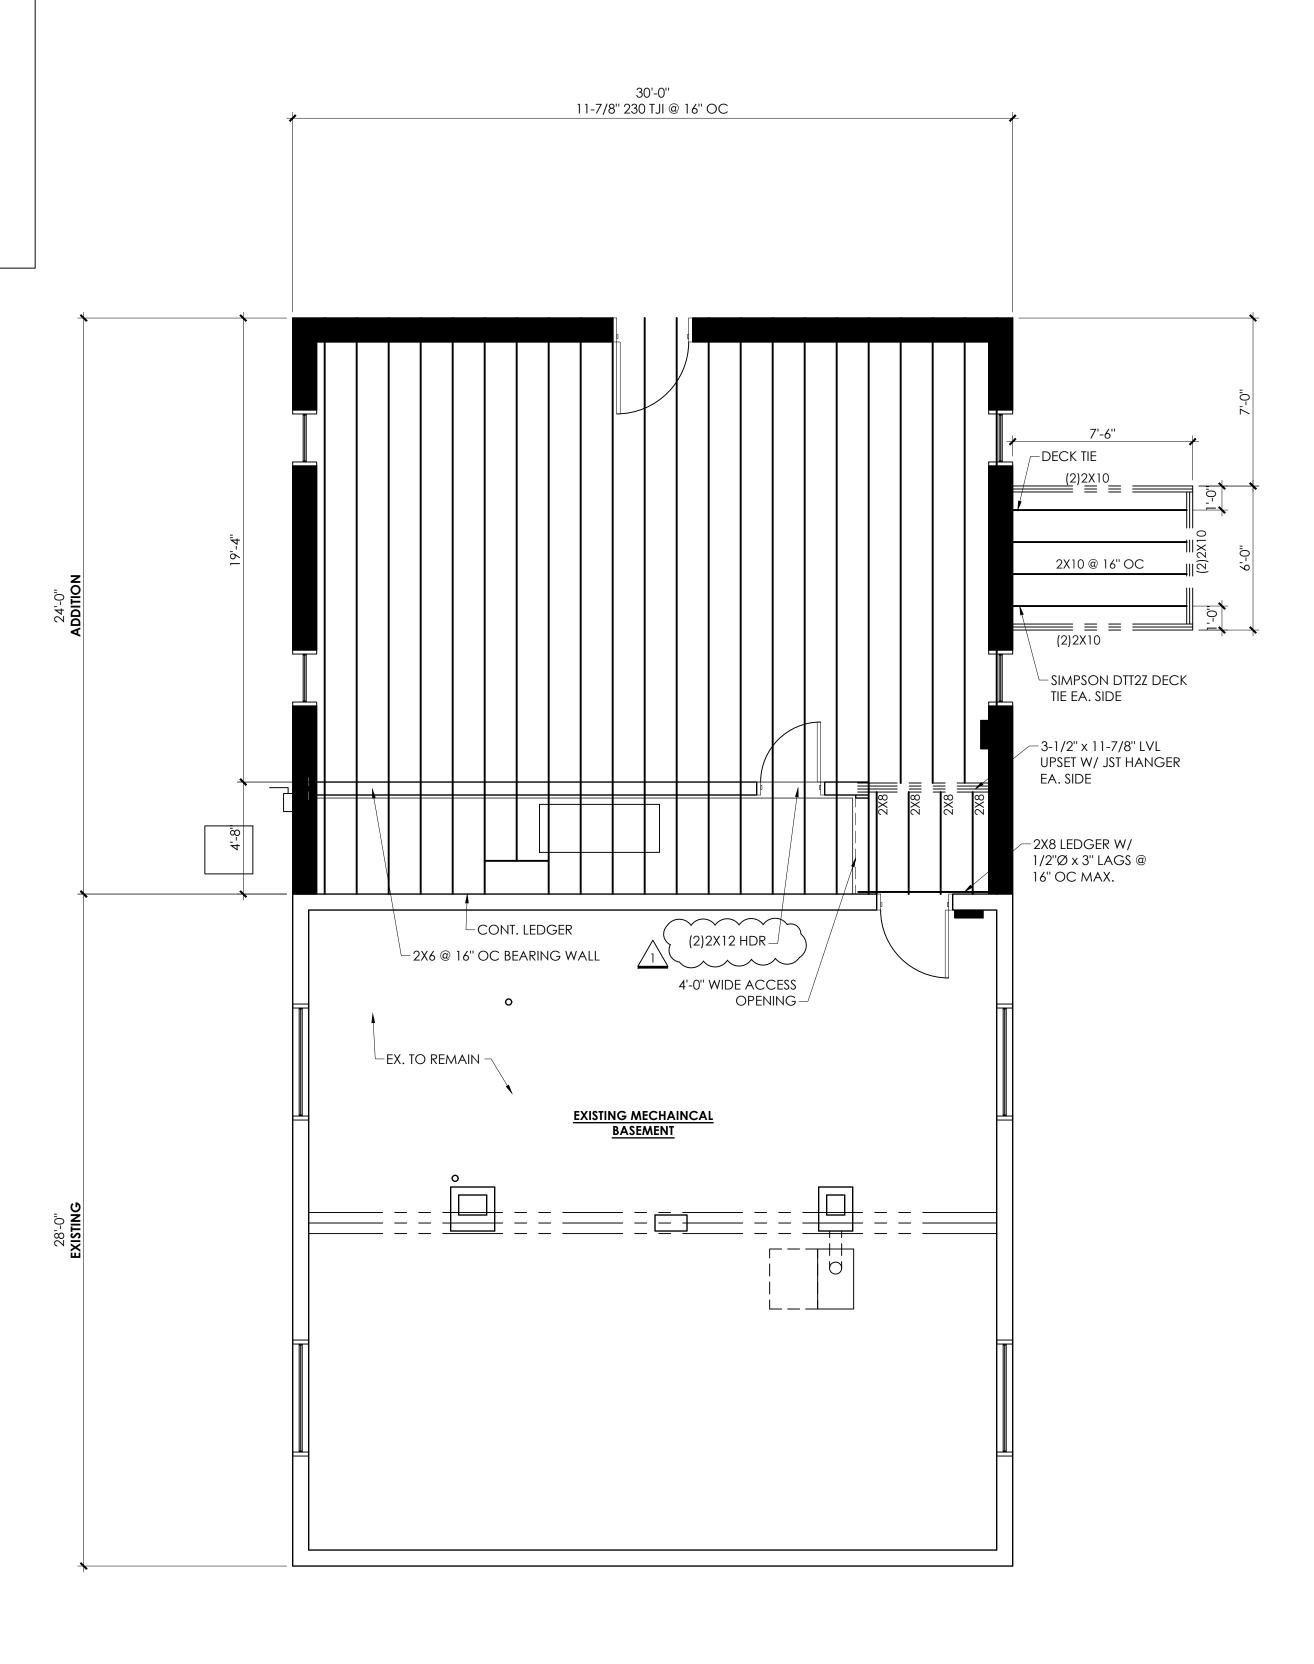

1ST FLOOR FRAMING PLAN

SCALE: 1/4" = 1'-0"

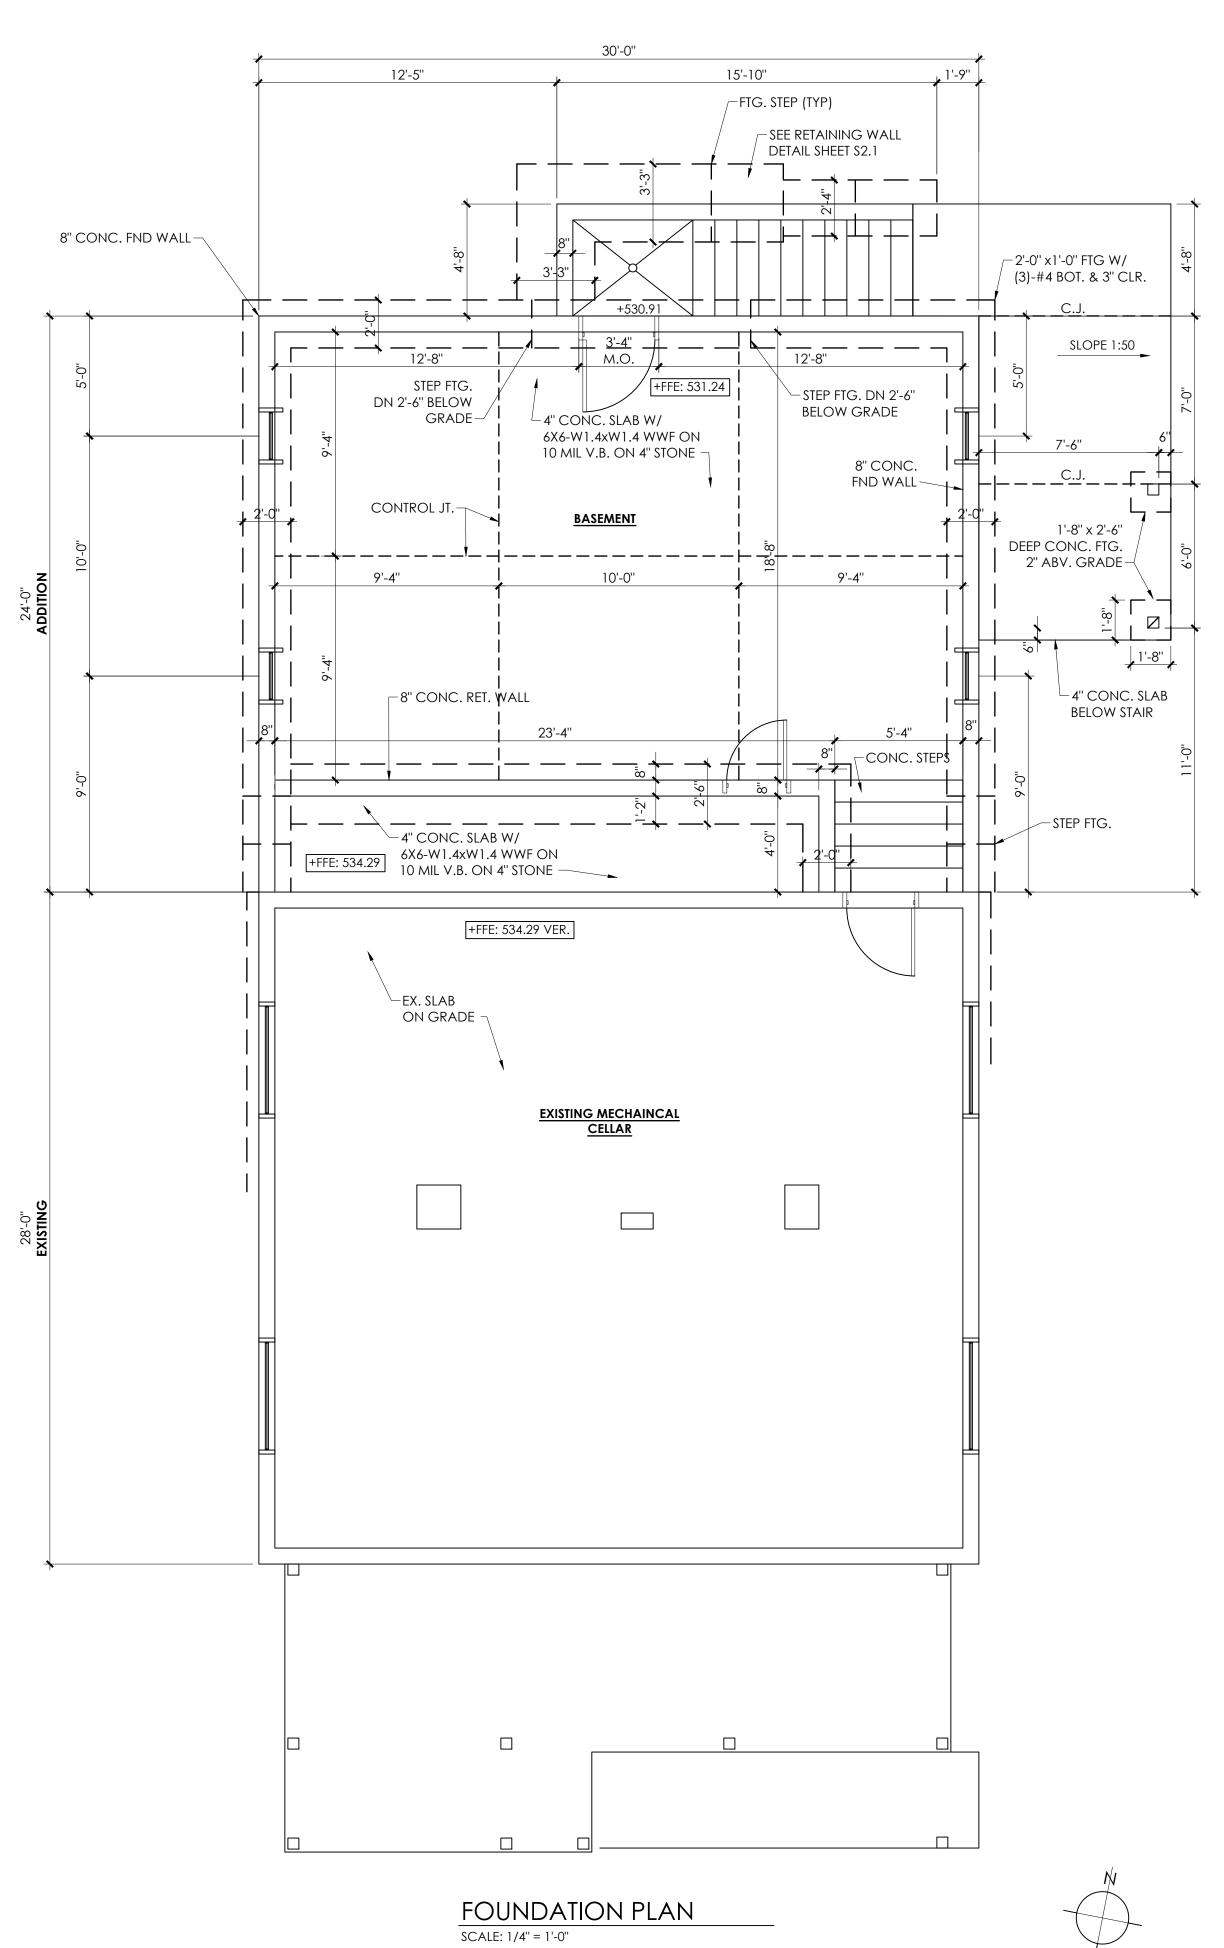

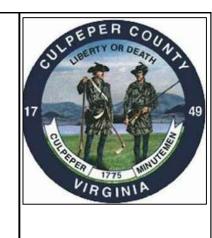


FOR CONSTRUCTION

S A N D E R S ARCHITECTURE PC 16125 RACCOON FORD RD CULPEPER, VIRGINIA 22701 (v)540-829-2590

VTY OPTIONS
ON
ON

PEPER COUNTY C
ADDITION
13033 JAMES MADISON HIGHY

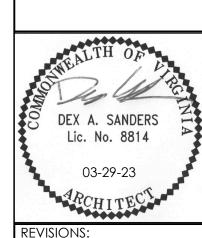

REVISIONS:

REV#1 REVIEW 09-19-23
REV#2 RE-BID 05-08-24

DRAWN:
CHECKED:
SCALE: NO

PROJECT #:


FOUNDATION / FRAMING PLAN

03-29-23

2127

\$1.1

SITE RETAINING WALL DETAIL

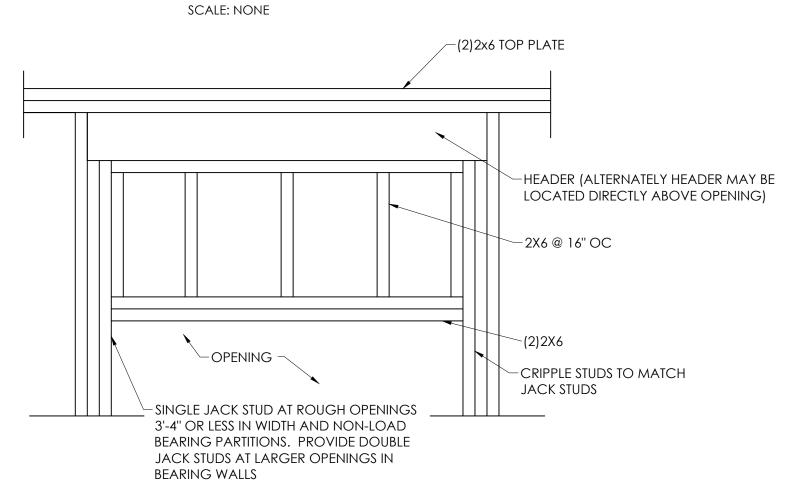

WHERE HEADERS ARE SHOWN ON FLOOR AND ROOF FRAMING PLANS, THE WALL DIRECTLY BELOW THE HEADER MAY BE CONSIDERED NON-LOAD BEARING.

2. HEADER SIZES:

NON-LOAD BEARING PARTITION LOAD BEARING WALL

(2)2X8 (3)2X10 U.N.O.

TYPICAL WALL OPENING HEADER DETAIL

SCALE: 3/4" = 1'-0"

ROOF FRAMING NOTES

1. ALL TRUSSES @ 24" OC MAXIMUM UNLESS NOTED OTHERWISE. WHERE TRUSSES ARE INDICATED AS SPREAD, PROVIDE 2X6 @ 24" OC TOP AND BOTTOM CHORDS.

2. CONTRACTOR TO PROVIDE ALL BLOCK'G, BRACING & OTHER FRAMING NECESSARY TO FRAME ALL CEILINGS, SOFFITS, CHASES & SKYLIGHTS.

3. CONTRACTOR TO PROVIDE WALK SURFACES & PLATFORMS TO ACCESS & MAINTAIN HVAC EQUIPMENT LOCATED ABOVE CEILING IN THE ATTIC SPACE. EQUIPMENT ACCESS AND SERVICE SPACE SHALL COMPLY WITH 2018 VIRGINIA MECHANICAL CODE.

4. COORDINATE EXACT EQUIPMENT LOCATIONS, WEIGHT AND DUCT ROUTING WITH TRUSS MFG.

5. COORDINATE FRESH AIR INTAKE LOUVERS & END WALL OPENINGS WITH TRUSS MFG.

6. TRUSSES TO BE DESIGNED BY MFG. ENGINEERED DRAWINGS ARE REQUIRED TO HAVE VIRGINIA PROFESSIONAL SEAL. SUBMIT SHOP DRAWINGS FOR REVIEW BEFORE FABRICATION.

7. DESIGN TRUSSES: L/480 FOR LIVE LOAD & L/360 FOR LIVE LOAD + DEAD LOAD. ATTIC NOT TO BE USED FOR STORAGE.

8. TRUSS MFG. TO PROVIDE TRUSS CLIPS FOR MULTIPLE PLY TRUSSES.

9. TRUSS MANUFACTURER SHALL DESIGN COMPLETE BRACING SYSTEM AND PROVIDE PLANS AND DETAILS OF BRACING AS PART OF TRUSS DRAWING SUBMITTAL. PROVIDE FULL BRACING REQUIRED FOR SUPPORT WITH NO INTERIOR OR EXTERIOR CEILING FINISHES.

PROVIDE COMPLETE BRACING FOR PIGGY BACK TRUSSES.

LAP SPLICES OF BRACING MEMBERS ACROSS (2) TRUSSES MINIMUM.

ROUGH CARPENTRY NOTES

ALL ROUGH CARPENTRY SHALL CONFORM TO THE

REQUIREMENTS OF THE NDS-2015.

2. PROVIDE NO 2 OR BETTER SOUTHERN PINE WITH MAXIMUM 19% MOISTURE CONTENT FOR ALL FRAMING LUMBER TO INCLUDE LINTELS & BEAMS U.N.O. WALL STUDS & PLATES SPF NO. 1 OR 2.

MEMBERS WHERE INDICATED AS MANUFACTURED BY TRUS
JOIST, BOISE, OR APPROVED EQUAL. FOLLOW
MANUFACTURER'S RECOMMENDATION FOR CONNECTING
MULTIPLE PLIES FOR SIDE OR TOP LOAD APPLICATIONS.

3. PROVIDE 2.0E MICROLAM (LVL) AND 1.8E PARALAM (PSL)

MULTIPLE PLIES FOR SIDE OR TOP LOAD APPLICATIONS.

4. FOLLOW MANUFACTURER'S RECOMMENDATION FOR FRAMING CONNECTIONS. FRAMING CONNECTIONS INDICATED REFERENCE SIMPSON PRODUCTS U.N.O.

5. PROVIDE 3" MINIMUM END BEARING FOR LVL BEAMS U.N.O.
6. PROVIDE (2)2X6 HEADER JACK STUDS AT ALL OPENINGS OVER

3'-6" UNLESS MORE ARE INDICATED.


7. U.N.O. <u>ALL</u> EXTERIOR WALLS AND GABLE ENDS TO HAVE MIN.

7/16" OSB SHEATHING PANELS INSTALLED ALONG STUDS &


CONTINUOUS HORIZONTAL BLOCKING W/ 6D NAILS @ 6" OC


MAXIMUM EDGES & 8" OC MAX. CENTER STUD. ALL STUDS TO

BE MAXIMUM OF 16" OC.

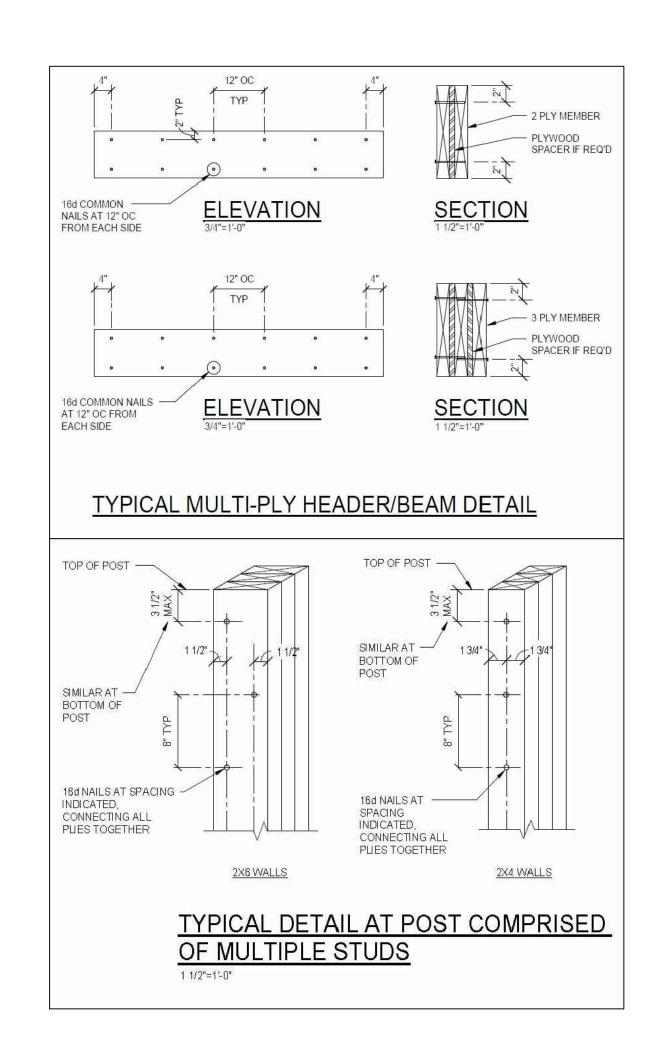

MEMBER	NAILS	CONNECTION		
JOIST TO SILL OR GIRDER	(3)8d COMMON (3)3" X 0.131" DIA	TOE NAIL		
BRIDGING TO JOIST	(2)8d COMMON (2)3" X 0.131" DIA	TOE NAIL EACH END		
SOLE PLATE TO JOIST OR BLOCKING	16d COMMON AT 16" OC 3" X 0.131" DIA AT 8" OC	FACENAL		
TOP PLATE TO STUD	(2) 16d COMMON (3) 3" X 0.131" DIA	END NAIL		
STUD TO SOLE PLATE	(4) 8d COMMON (4) 3" X 0.131" DIA	TOE NAIL		
	(2) 16d COMMON (3) 3" X 0.131" DIA	END NAIL		
DOUBLED STUDS	16d COMMON AT 24" OC 3" X 0.131" DIA AT 8" OC	FACENAL		
DOUBLED TOP PLATE	16d COMMON AT 16" OC 3" X 0.131" DIA AT 8" OC	FACENAL		
DOUBLED TOP PLATE LAP SPLICE	(8) 16d C OM MON (12) 3" X 0.131" DIA	FACENAL		
TOP PLATE INTERSECTIONS	(2)16d COMMON (3)3" X 0.131" DIA	FACENAL		
CONTINUOUS HEADER-MULTI-PLY	16d COMMON AT 16" OC	FACE NAIL ALONG EACH EDGE		
CONTINUOUS HEADER TO STUD	(4)8d COMMON	TOE NAIL		
BUILT-UP CORNER STUDS, EACH BRG	16d COMMON AT 24" OC 3" X 0.131" DIA AT 16" OC	FACENAIL		
RIM JOIST TO TOP PLATE	8d COMMON AT 6" OC 3" X 0.131" DIA AT 6" OC	TOE NAIL		

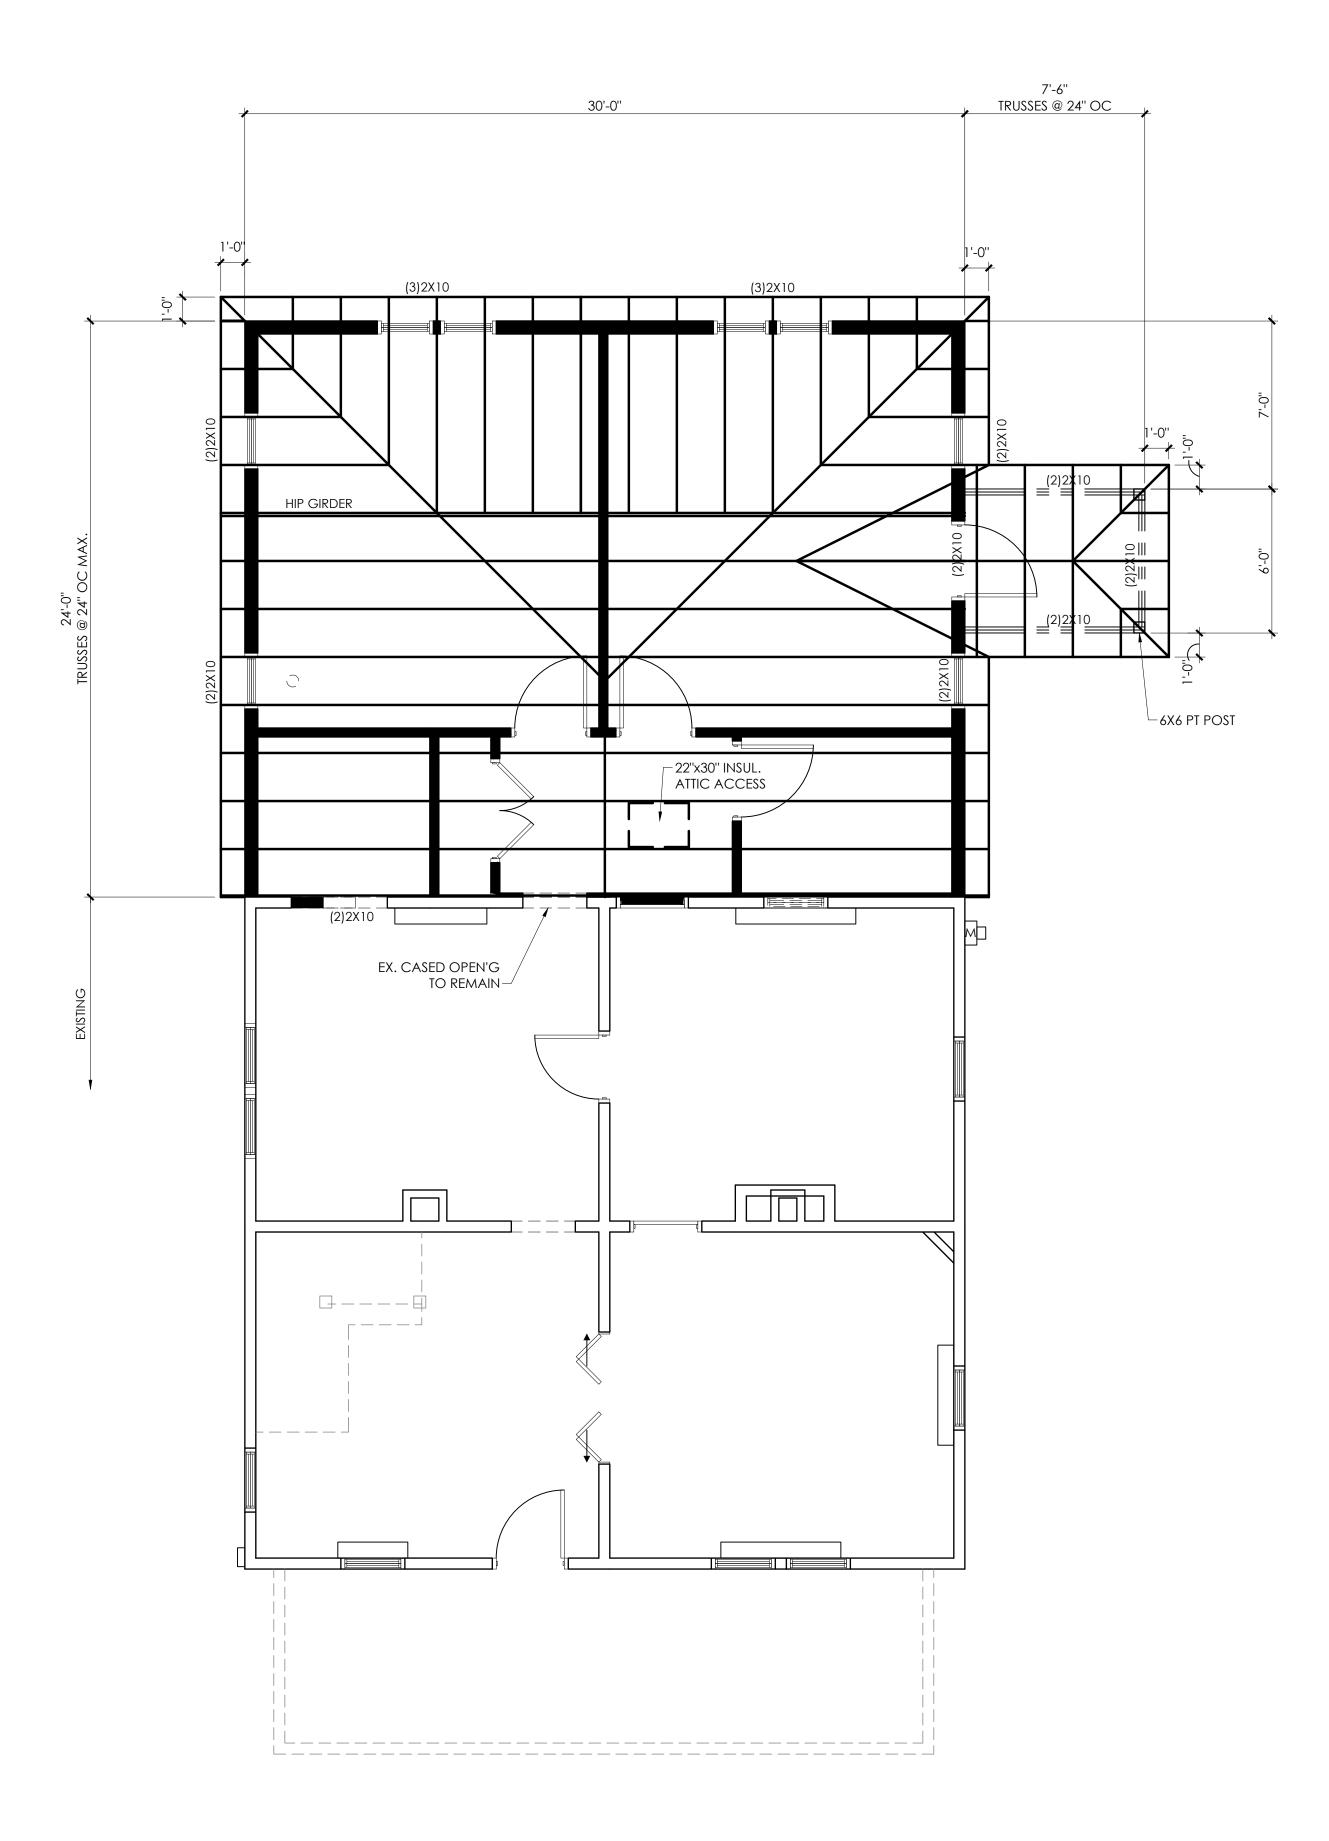

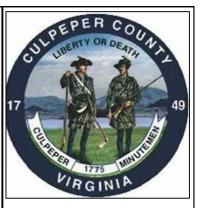


NSTRUCTION

NDER:

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ADDITION
13033 JAMES MADISON HIGHWA

OUNTY

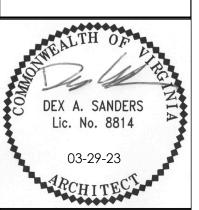

REVISIONS:


REV#1 REVIEW 09-19-23
REV#2 RE-BID 05-08-24

DRAWN: DAS
CHECKED:
SCALE: NOTED
DATE: 03-29-23
PROJECT #: 2127

FOUNDATION / FRAMING PLAN

S2.1

ROOF FRAMING PLAN
SCALE: 1/4" = 1'-0"

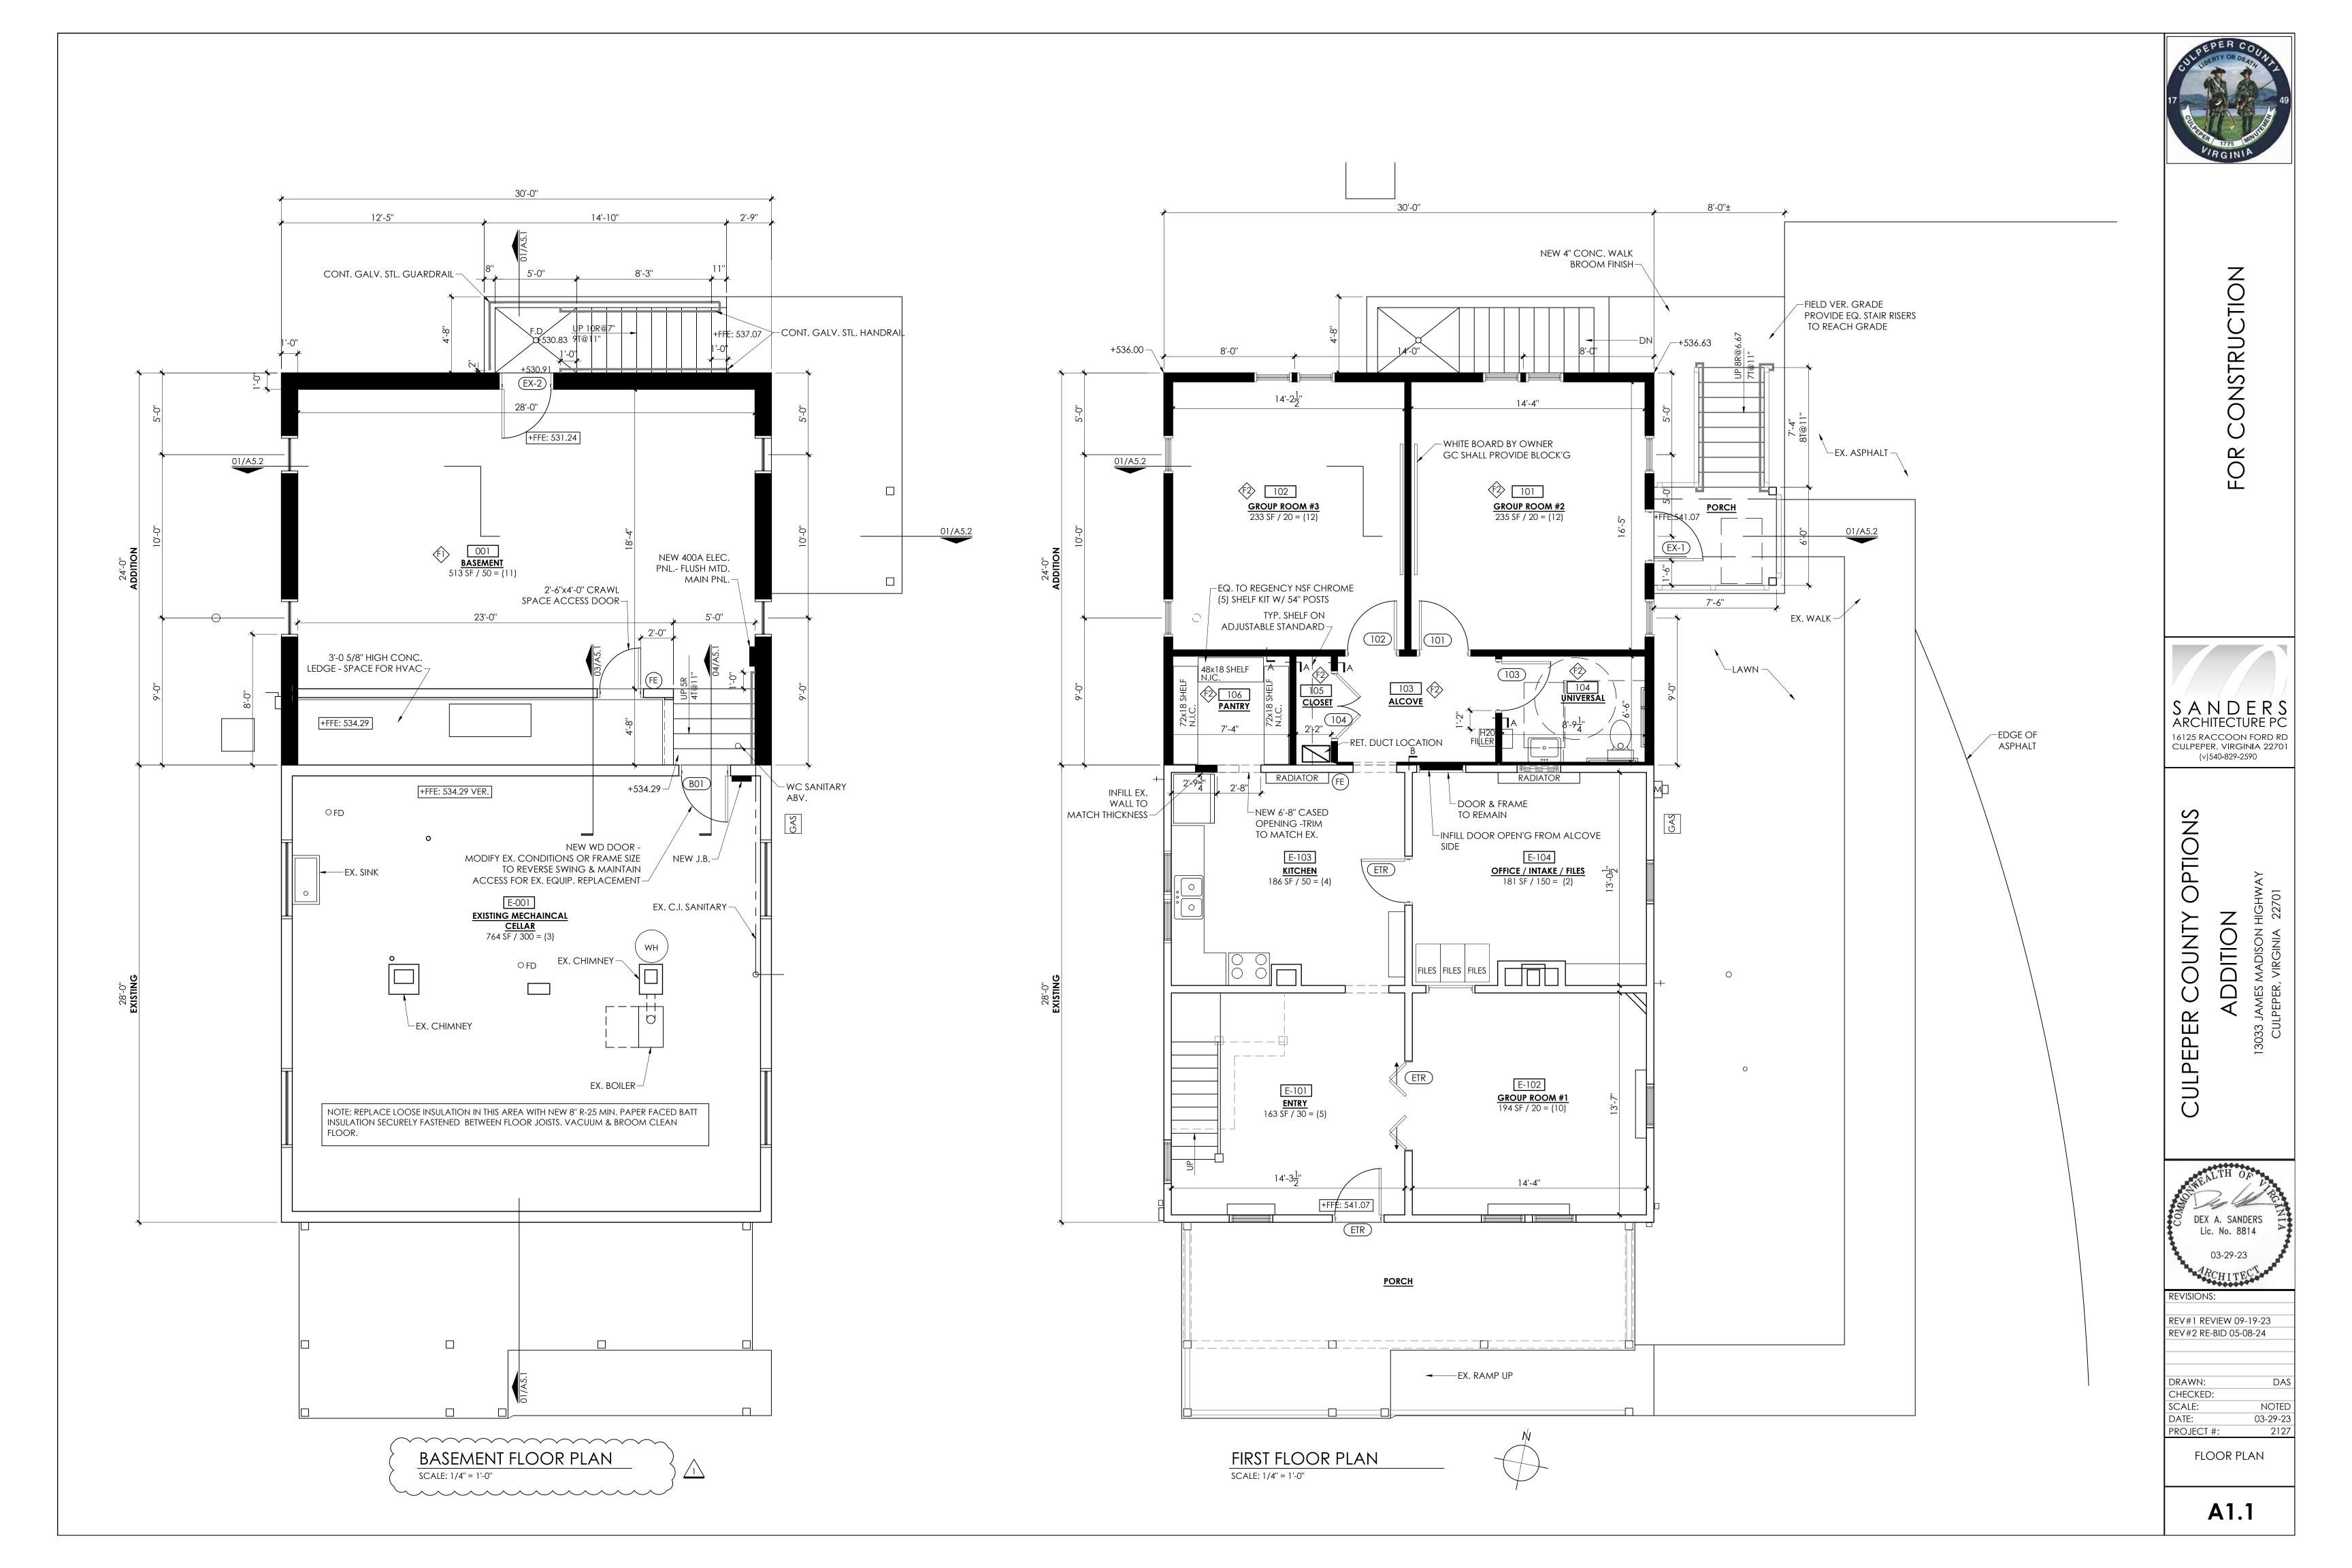

- 1. SEE CEILING PLAN FOR EXTENT OF PAINTED SOFFITS & SUSPENDED
- 2. COLORS TO BE SELECTED BY OWNER
- 3. PROVIDE MR GPDW BEHIND ALL TILED WALLS
- 4. PROVIDE SW DURATION PAINT FOR INTERIOR PUBLIC SPACES TO INCLUDE GROUP ROOMS, ALCOVE AND TOILET.

FLOOR - CLEAR CONCRETE SEALER BASE - 4" RUBBER WALLS - PTD EGGSHELL ENAMEL TRIM - PTD. SEMI-GLOSS

CEILING - PTD. EGGSHELL ENAMEL

F-2 FLOOR - LVT -1 EQ. TO INTERFACE BASE - WOOD WM 620 W/ WM127 SHOE - PTD SEMI-GLOSS WALLS - PTD SEMI-GLOSS ENAMEL TRIM - WOOD WM412 W/ WM520 TOP CAP - PTD SEMI-GLOSS CEILING - PTD. EGGSHELL ENAMEL


WALL TYPES ¬A

NOTES:

- 1. PROVIDE 3" SOUND BATTS INSULATION IN ALL INTERIOR PARTITIONS BETWEEN ACOUSTICALLY SEPARATED AND OCCUPIED SPACES TO INCLUDE GROUP ROOMS AND TOILET U.N.O.
- 2. SEAL AROUND ALL EDGES AT SOUND PARTITIONS WITH FLEXIBLE SEALANT.
- 3. PROVIDE MR GPDW AT WET WALLS (WHERE NOT FIRE RATED) 4. ALL PARTITIONS TO EXTEND TO U/S OF ROOF STRUCTURE U.N.O. SEE FLOOR PLAN & SECTIONS. ALLOW FOR TRUSS MOVEMENT IN GWB INSTALLATION.
- 5. THICKEN PARTITIONS & PROVIDE CHASES TO CONCEAL MECHANICAL, ELECTRICAL AND PLUMBING SYSTEMS.

TYPE 'A' 1/2" GWB EACH SIDE ON 2X4 STUDS @ 16" OC MAX. (3" SOUND BATTS) - TYPICAL ALL WALLS U.N.O.

TYPE 'B' 1/2" GWB 2X2 WD STUDS @ 16" OC MAX.

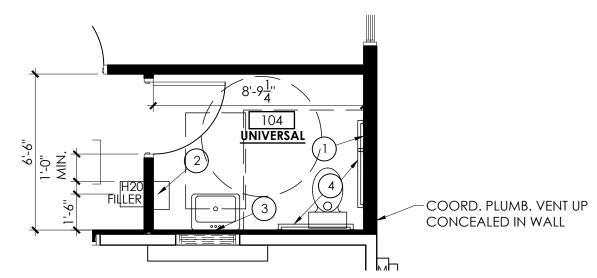

ENGLARGED TOILET PLAN SCALE: 1/4" = 1'-0"


WASHROOM ACCESSORIES 1

- TOILET TISSUE HOLDER: BOBRICK SS NON-SECURITY DOUBLE ROLL HOLDER. (1) AT
- HAND TOWEL DISPENSER PROVIDED BY OWNER AND INSTALLED BY GC. MOUNT 48" TO TOP OF OPERABLE PARTS.
- MIRROR: LENGTH OF COUNTER OR LAV. (24" WIDE MIN) x 3'-0" HIGH $\frac{1}{4}$ " FLOAT GLASS FRAMED MIRROR - SECURELY GLUED & CLIPPED TO WALL. MIRROR SHALL BE GUARANTEED AGAINST SILVER SPOILAGE FOR 15 YEARS.
- TOILET STALL GRAB BARS: EQ. TO ASI 3800 SERIES W/ INTEGRAL NON-SLIP SURFACE. PROVIDE (1)-42" LONG & (1)-36" & (1) 18" LONG GRAB BAR AS INDICATED IN EACH ACCESSIBLE TOILET STALL.

NOTE: CONTRACTOR TO VERIFY BLOCKING LOCATIONS OF ALL ACCESSORIES, INCLUDING SOAP & TOWEL DISPENSERS PROVIDED BY OWNER.


BUILT-IN SHELF NOTES

1. WHERE UTILITY TYPE SHELVES ARE INDICATED IN CLOSETS, AND JANITOR CLOSET BY A DASHED LINE, PROVIDE $\frac{3}{4}$ THICKNESS A/B PTD. PLYWD SHELVES MIN 12" WIDE. INSTALL SHELVES ON HEAVY-DUTY ADJUSTABLE SHELF STANDARDS AND SNAP-IN PLACE BRACKETS OF THE PROPER WIDTH. U.N.O. PROVIDE (1) SHELF AND 24" LONG SHELF STANDARD BRACKETS @ 16" OC.

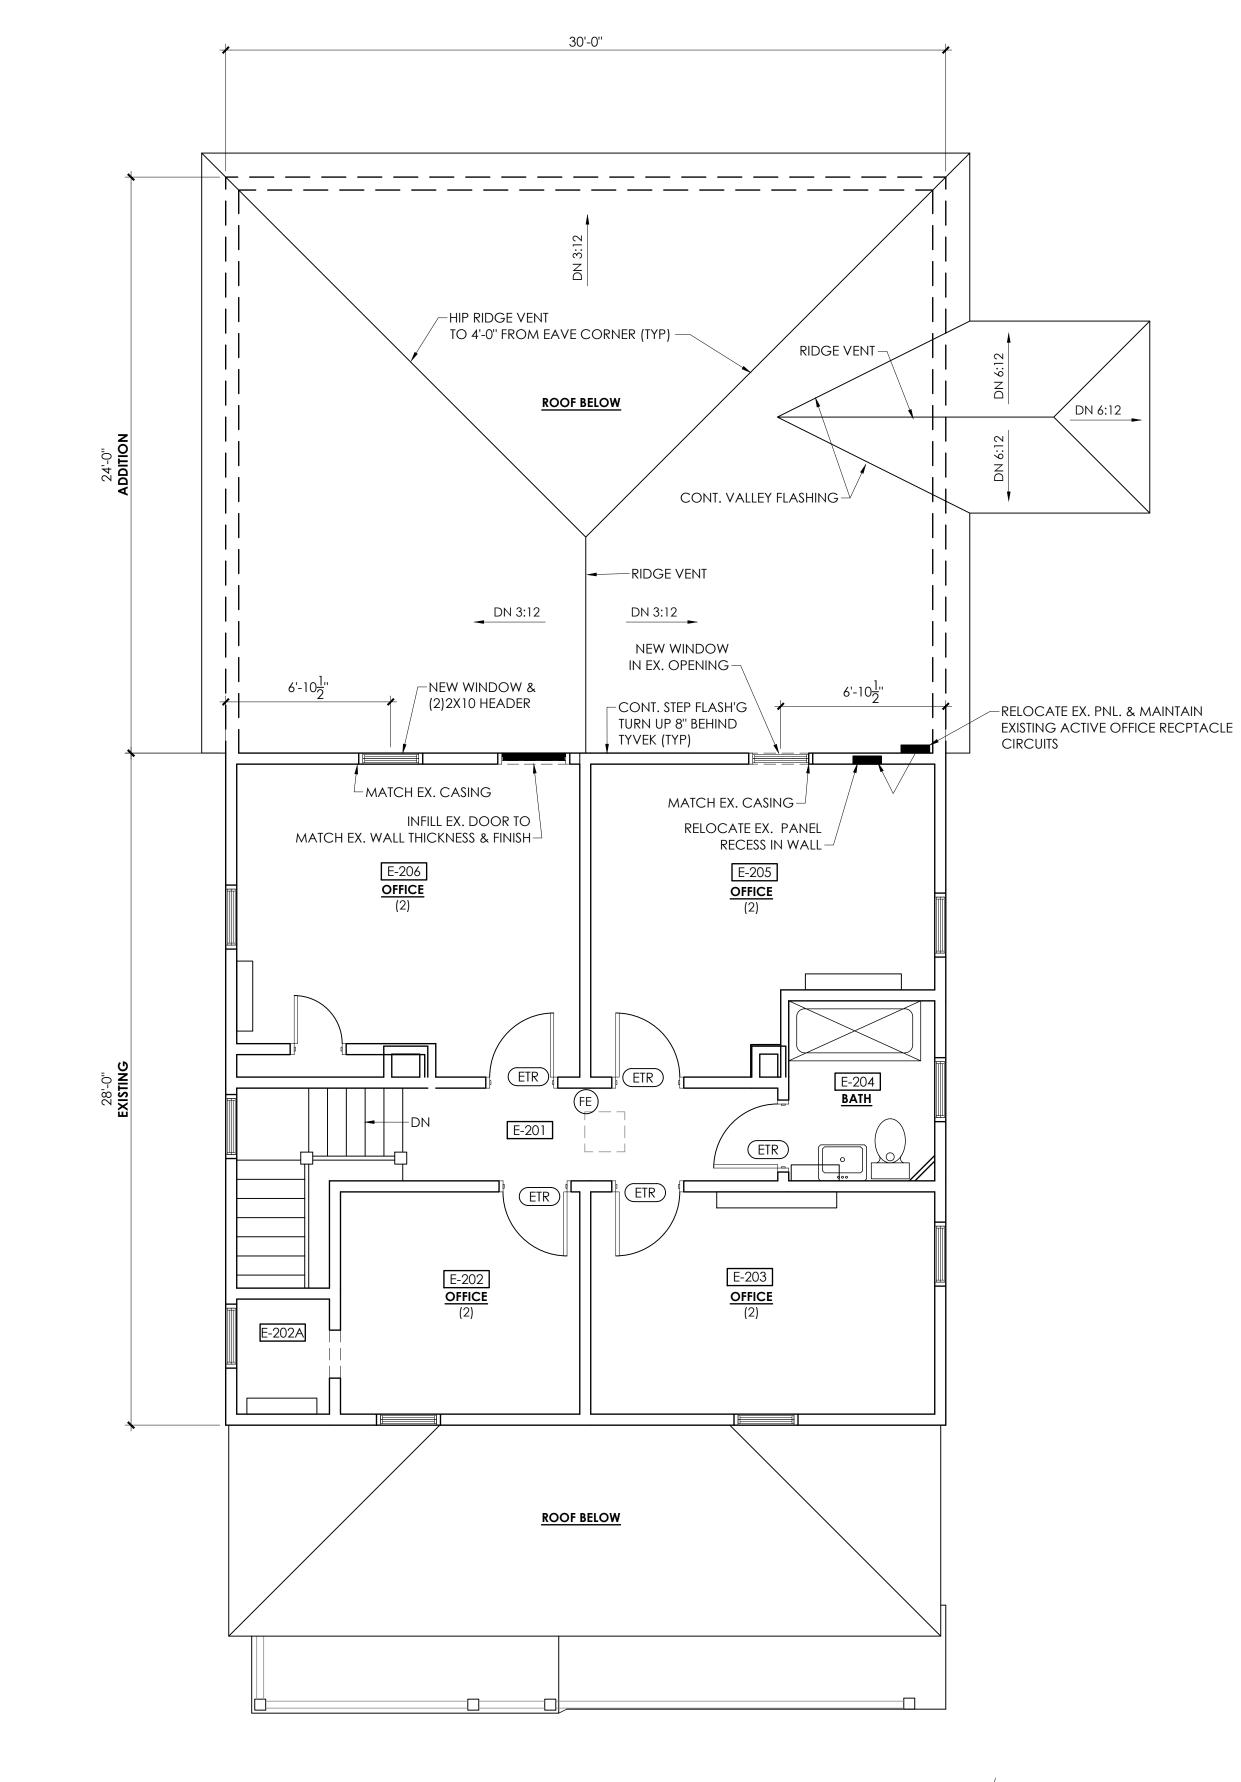

2ND FLOOR PLAN SCALE: 1/4" = 1'-0"




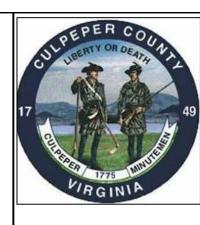

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OPTIONS COUNTY ER CULPEP



REVISIONS: REV#1 REVIEW 09-19-23

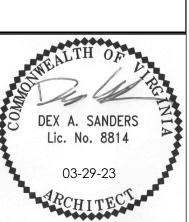
REV#2 RE-BID 05-08-24


NOTED 03-29-23 PROJECT #: 2127

CHECKED:

FLOOR PLAN


A1.2

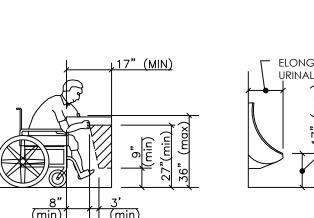


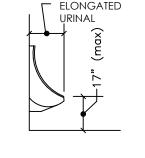


WATER COOLER

MOUNTING HEIGHTS SCALE: NONE

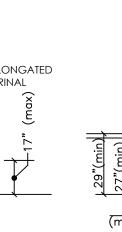


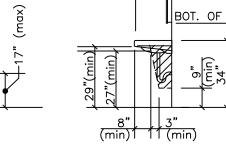



LAVATORY

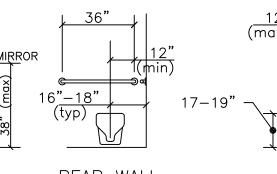




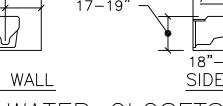

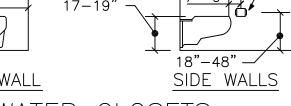

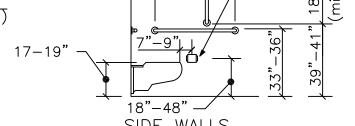

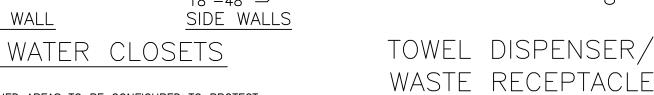

REACH HEIGHTS SHOWN ARE TYPICAL TO OPERABLE PARTS


FOR ALL DEVICES INCLUDING RECEPTCALES / PULL STATIONS

EQUIPMENT PERMITTED IN HATCHED AREAS TO BE CONFIGURED TO PROTECT STANDARDS SHOW TYPICAL ACCESSIBLE MOUNTING HEIGHTS & CLEARANCES. SPECIFIED PRODUCTS MAY VARY FROM DETAIL IMAGE. SPECIAL MOUNTING HEIGHTS MAY BE INDICATED ON OTHER SHEETS.

ORDER TOILETS WITH FLUSH VALVES ON THE OPEN SIDE OF THE TOILET.

REACH HEIGHTS SHOWN ARE TO OPERABLE PARTS (TYPICAL)



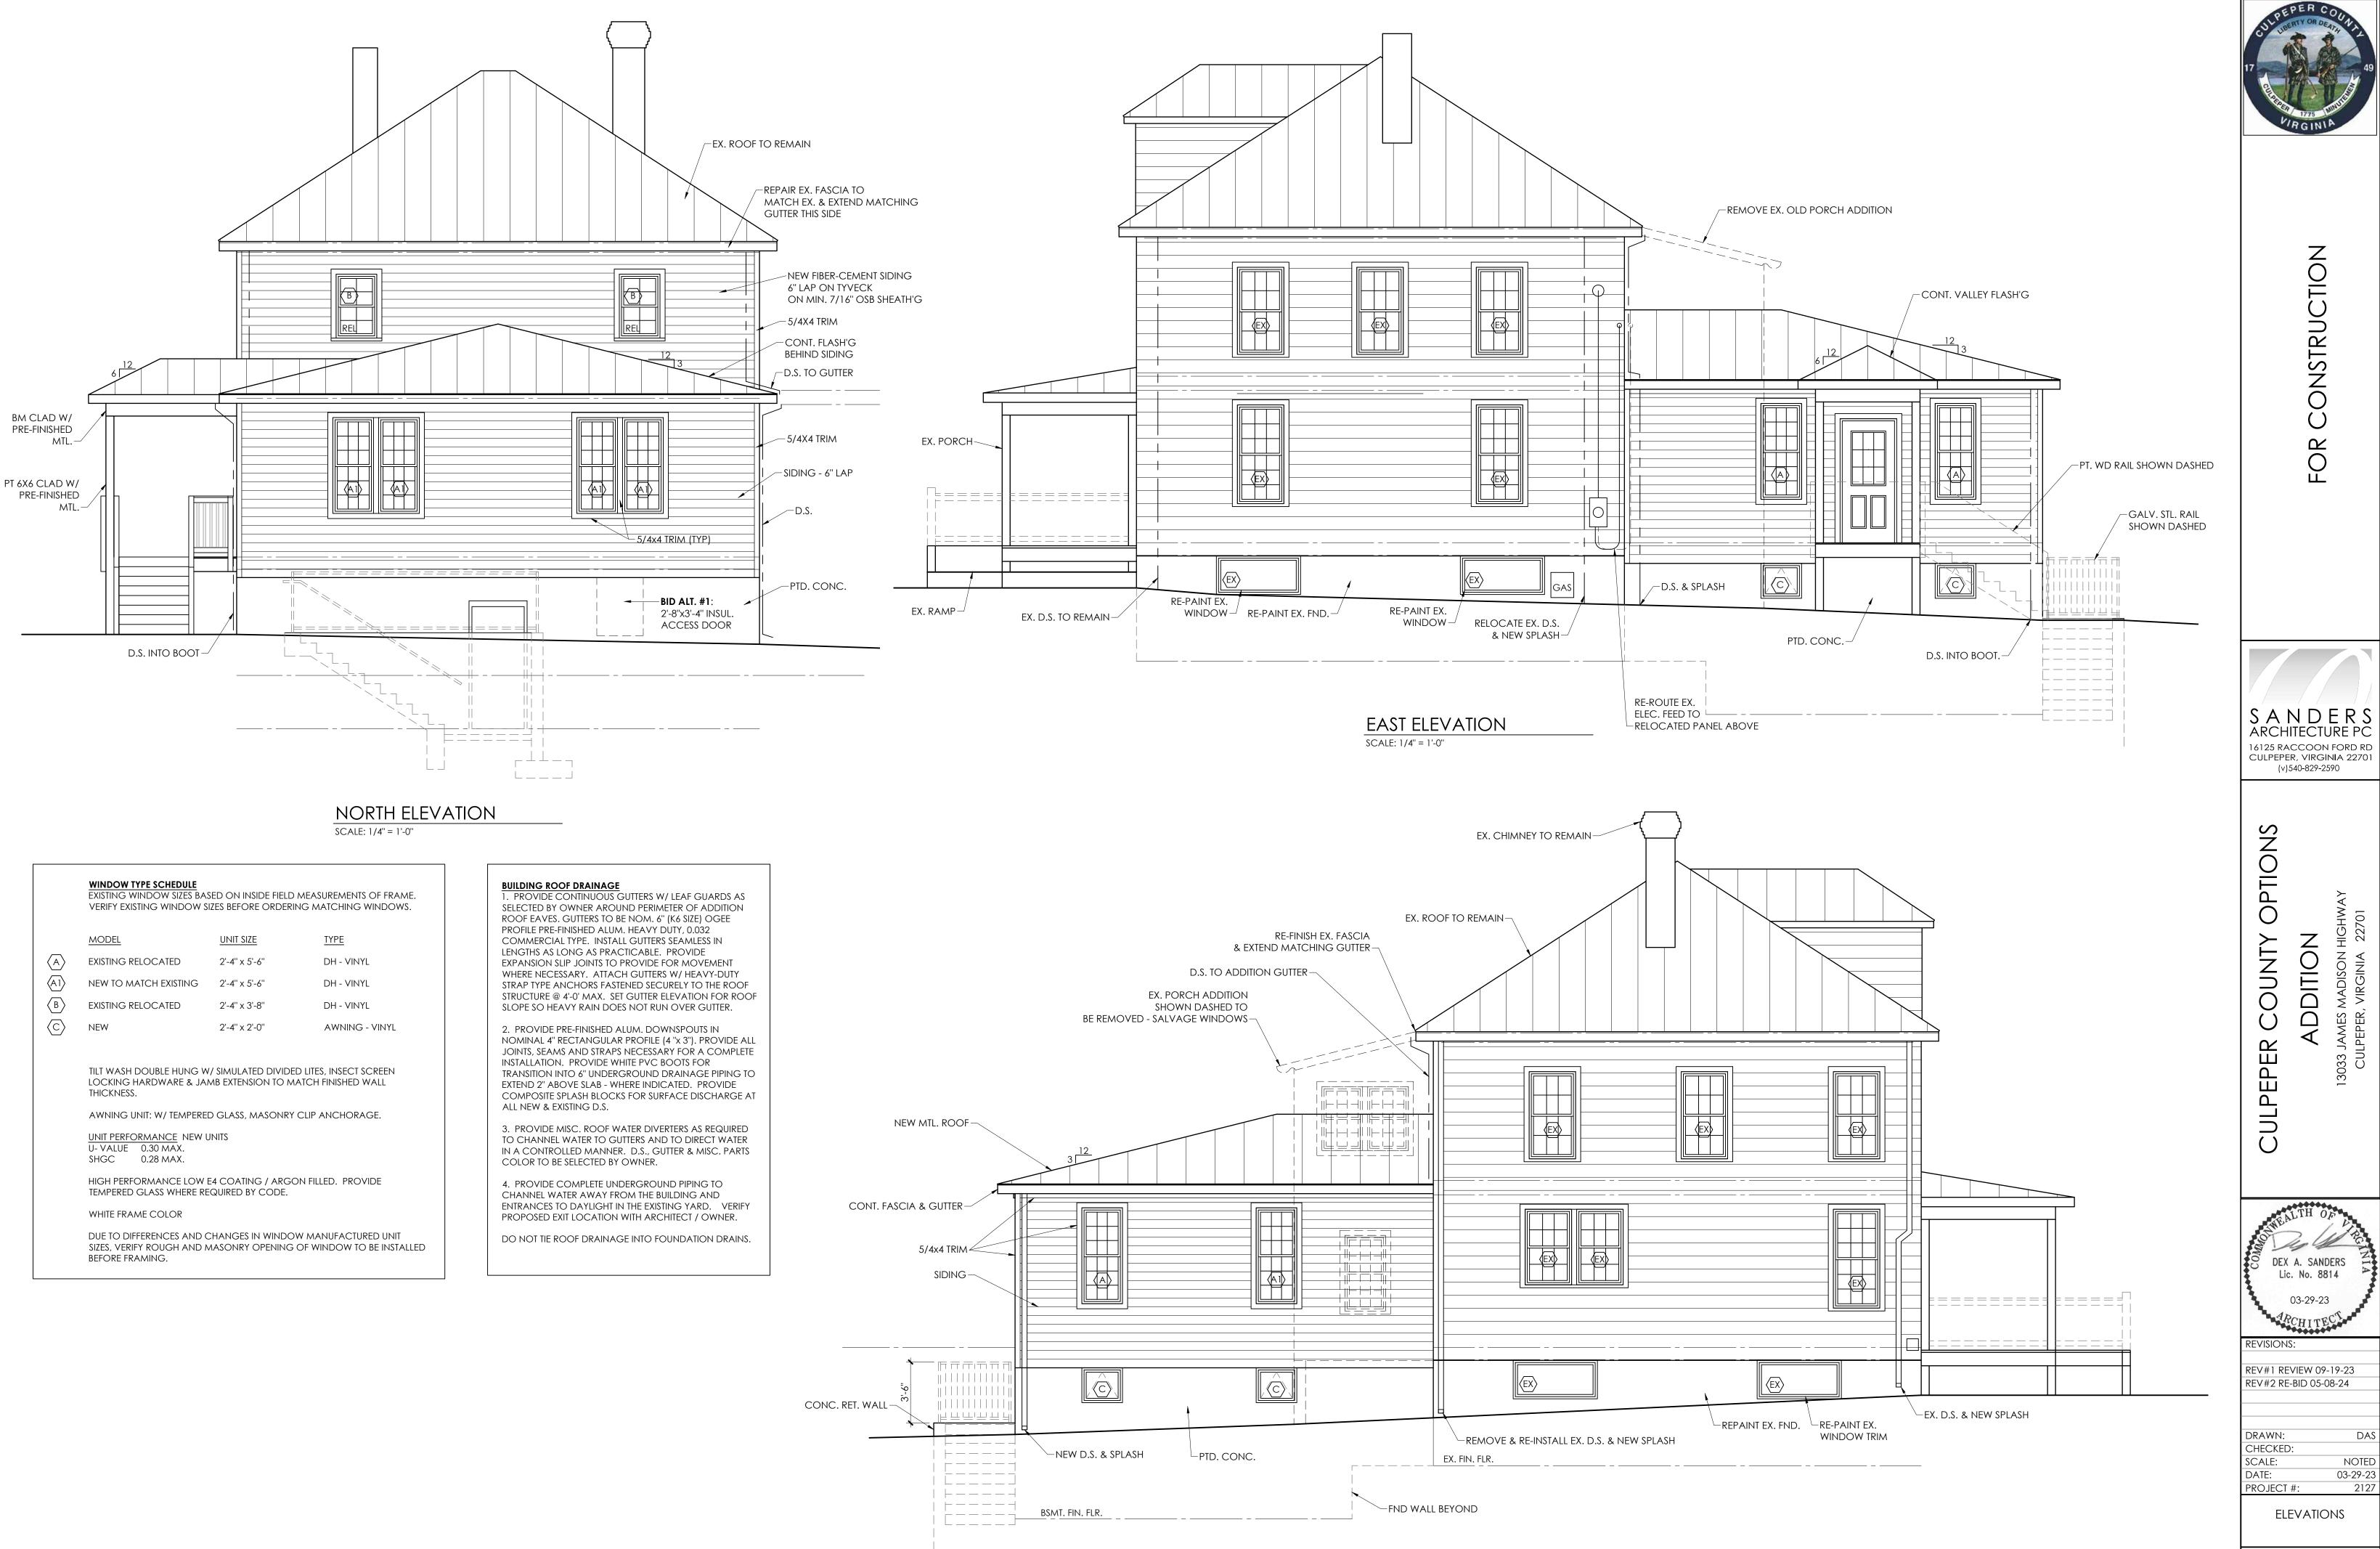

WEST ELEVATION

SCALE: 1/4" = 1'-0"

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DEX A. SANDERS Lic. No. 8814 03-29-23


REV#1 REVIEW 09-19-23 REV#2 RE-BID 05-08-24


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2127

ELEVATIONS

A4.1



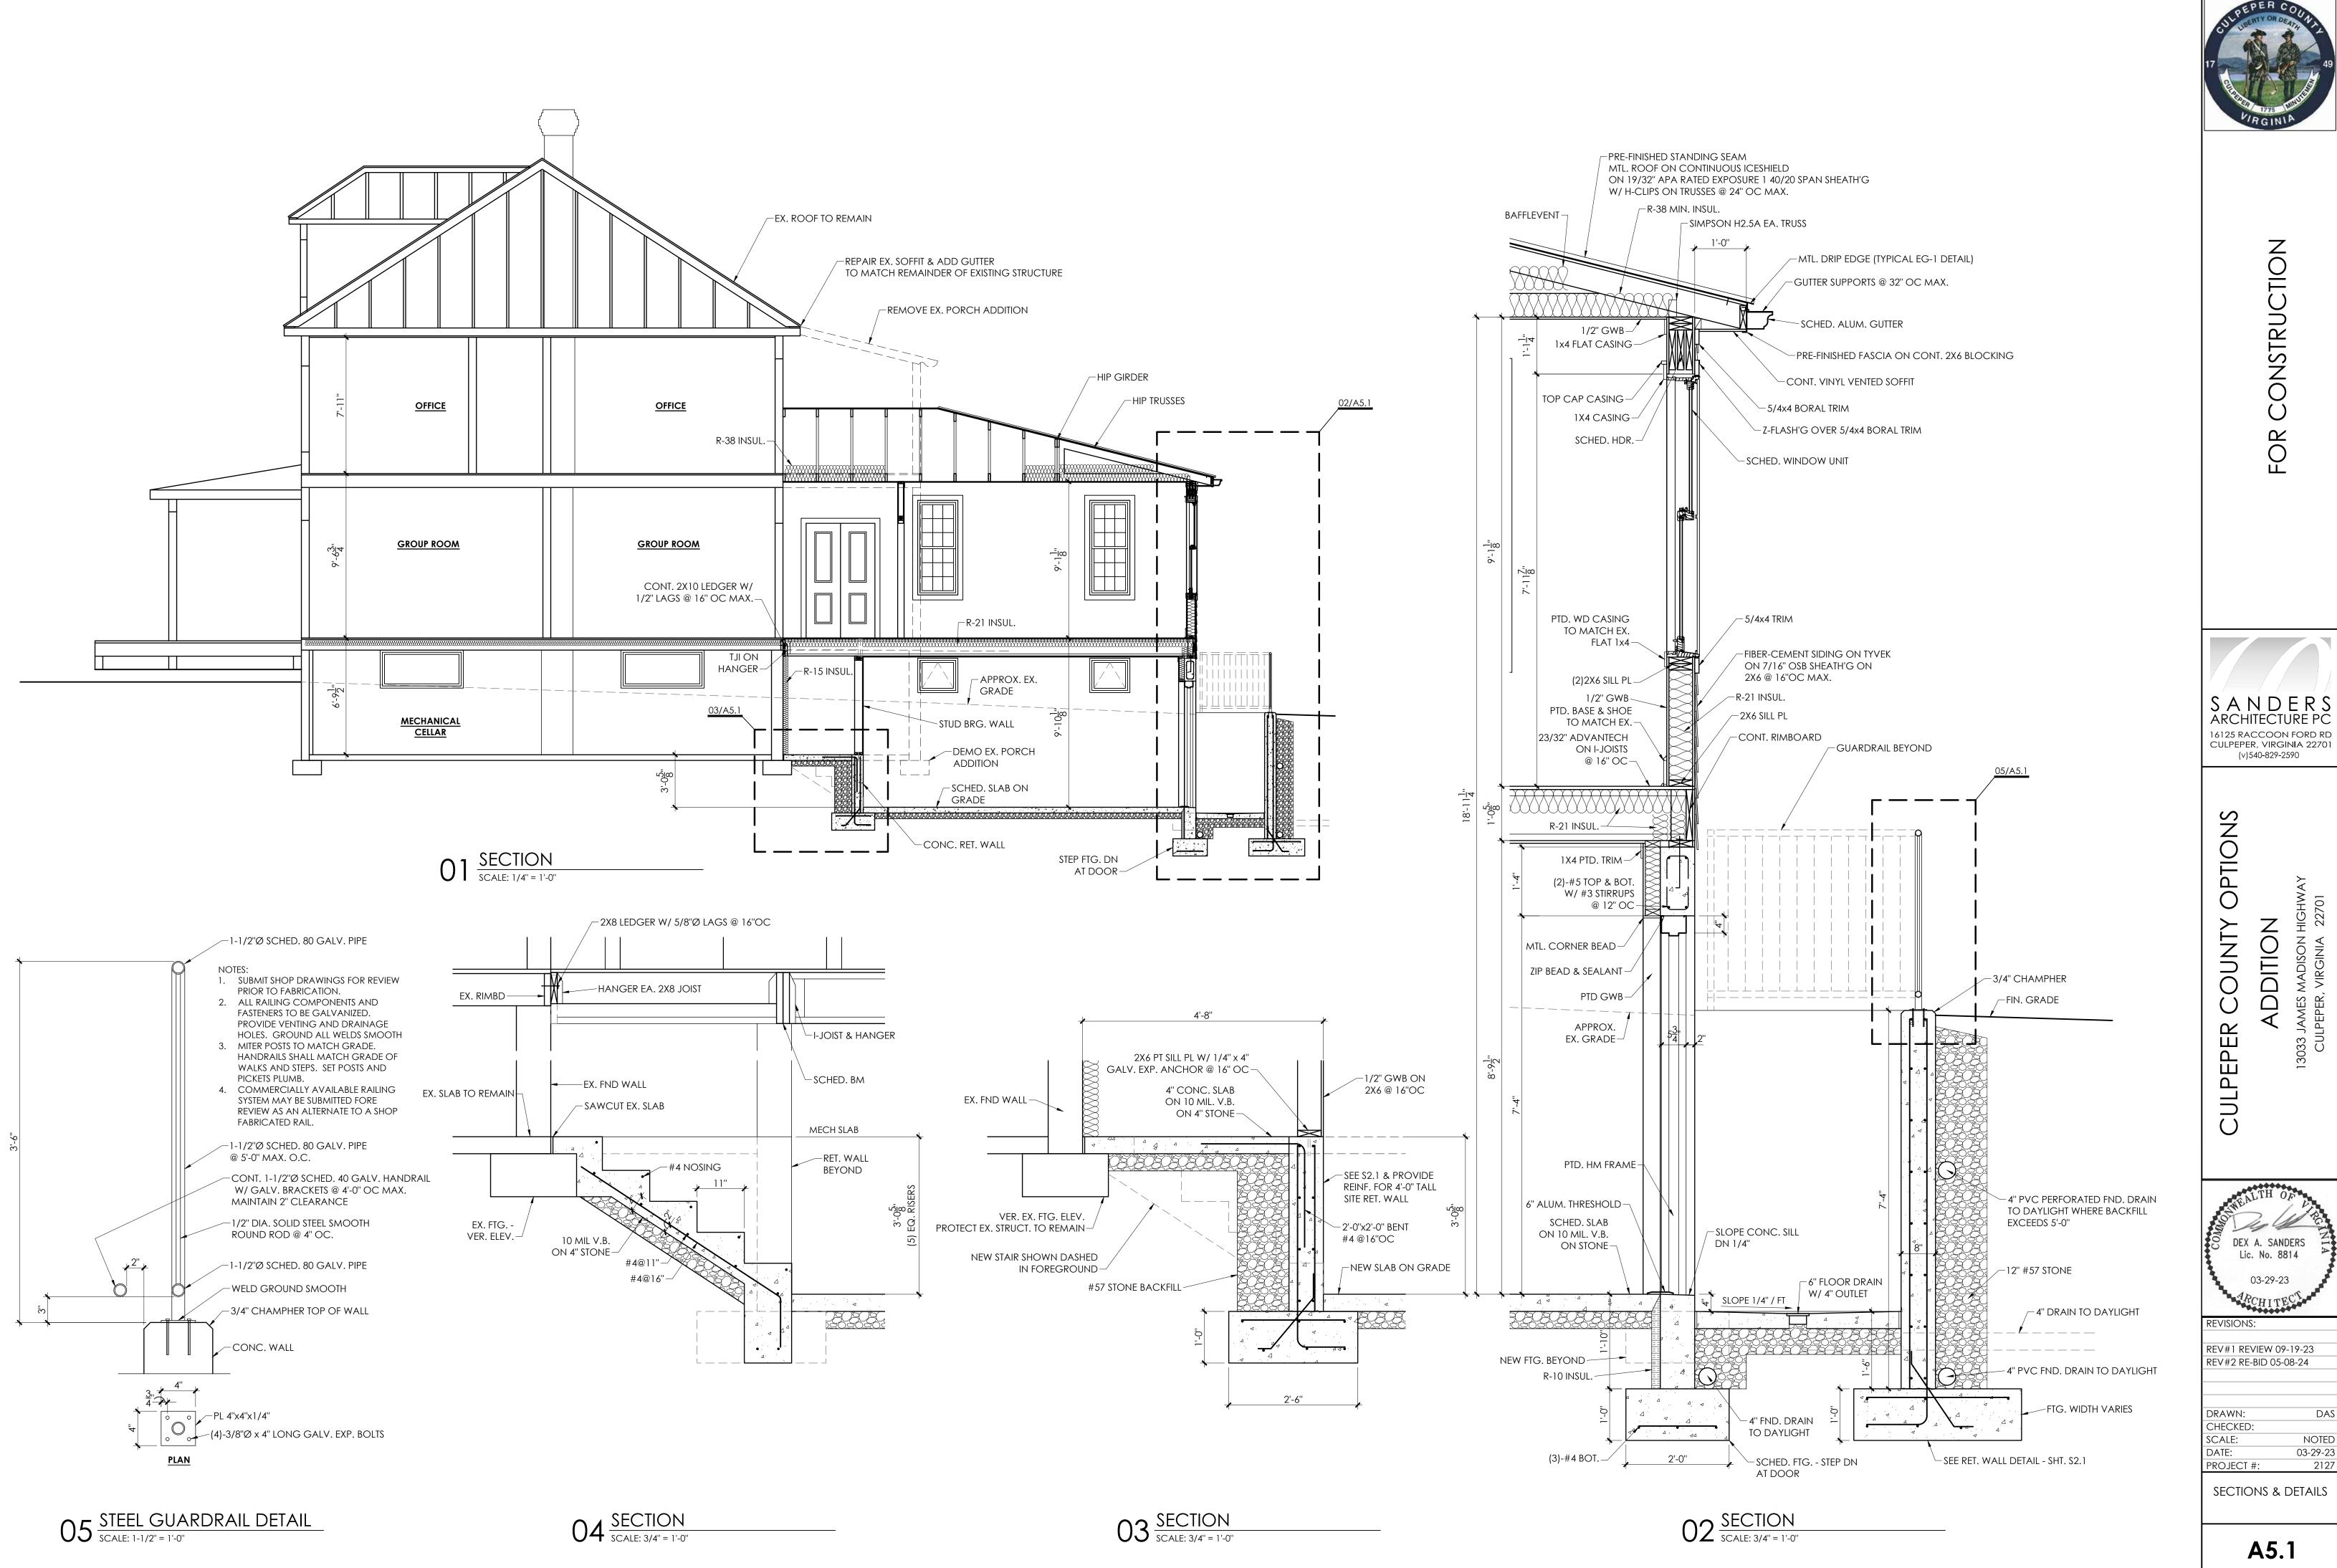

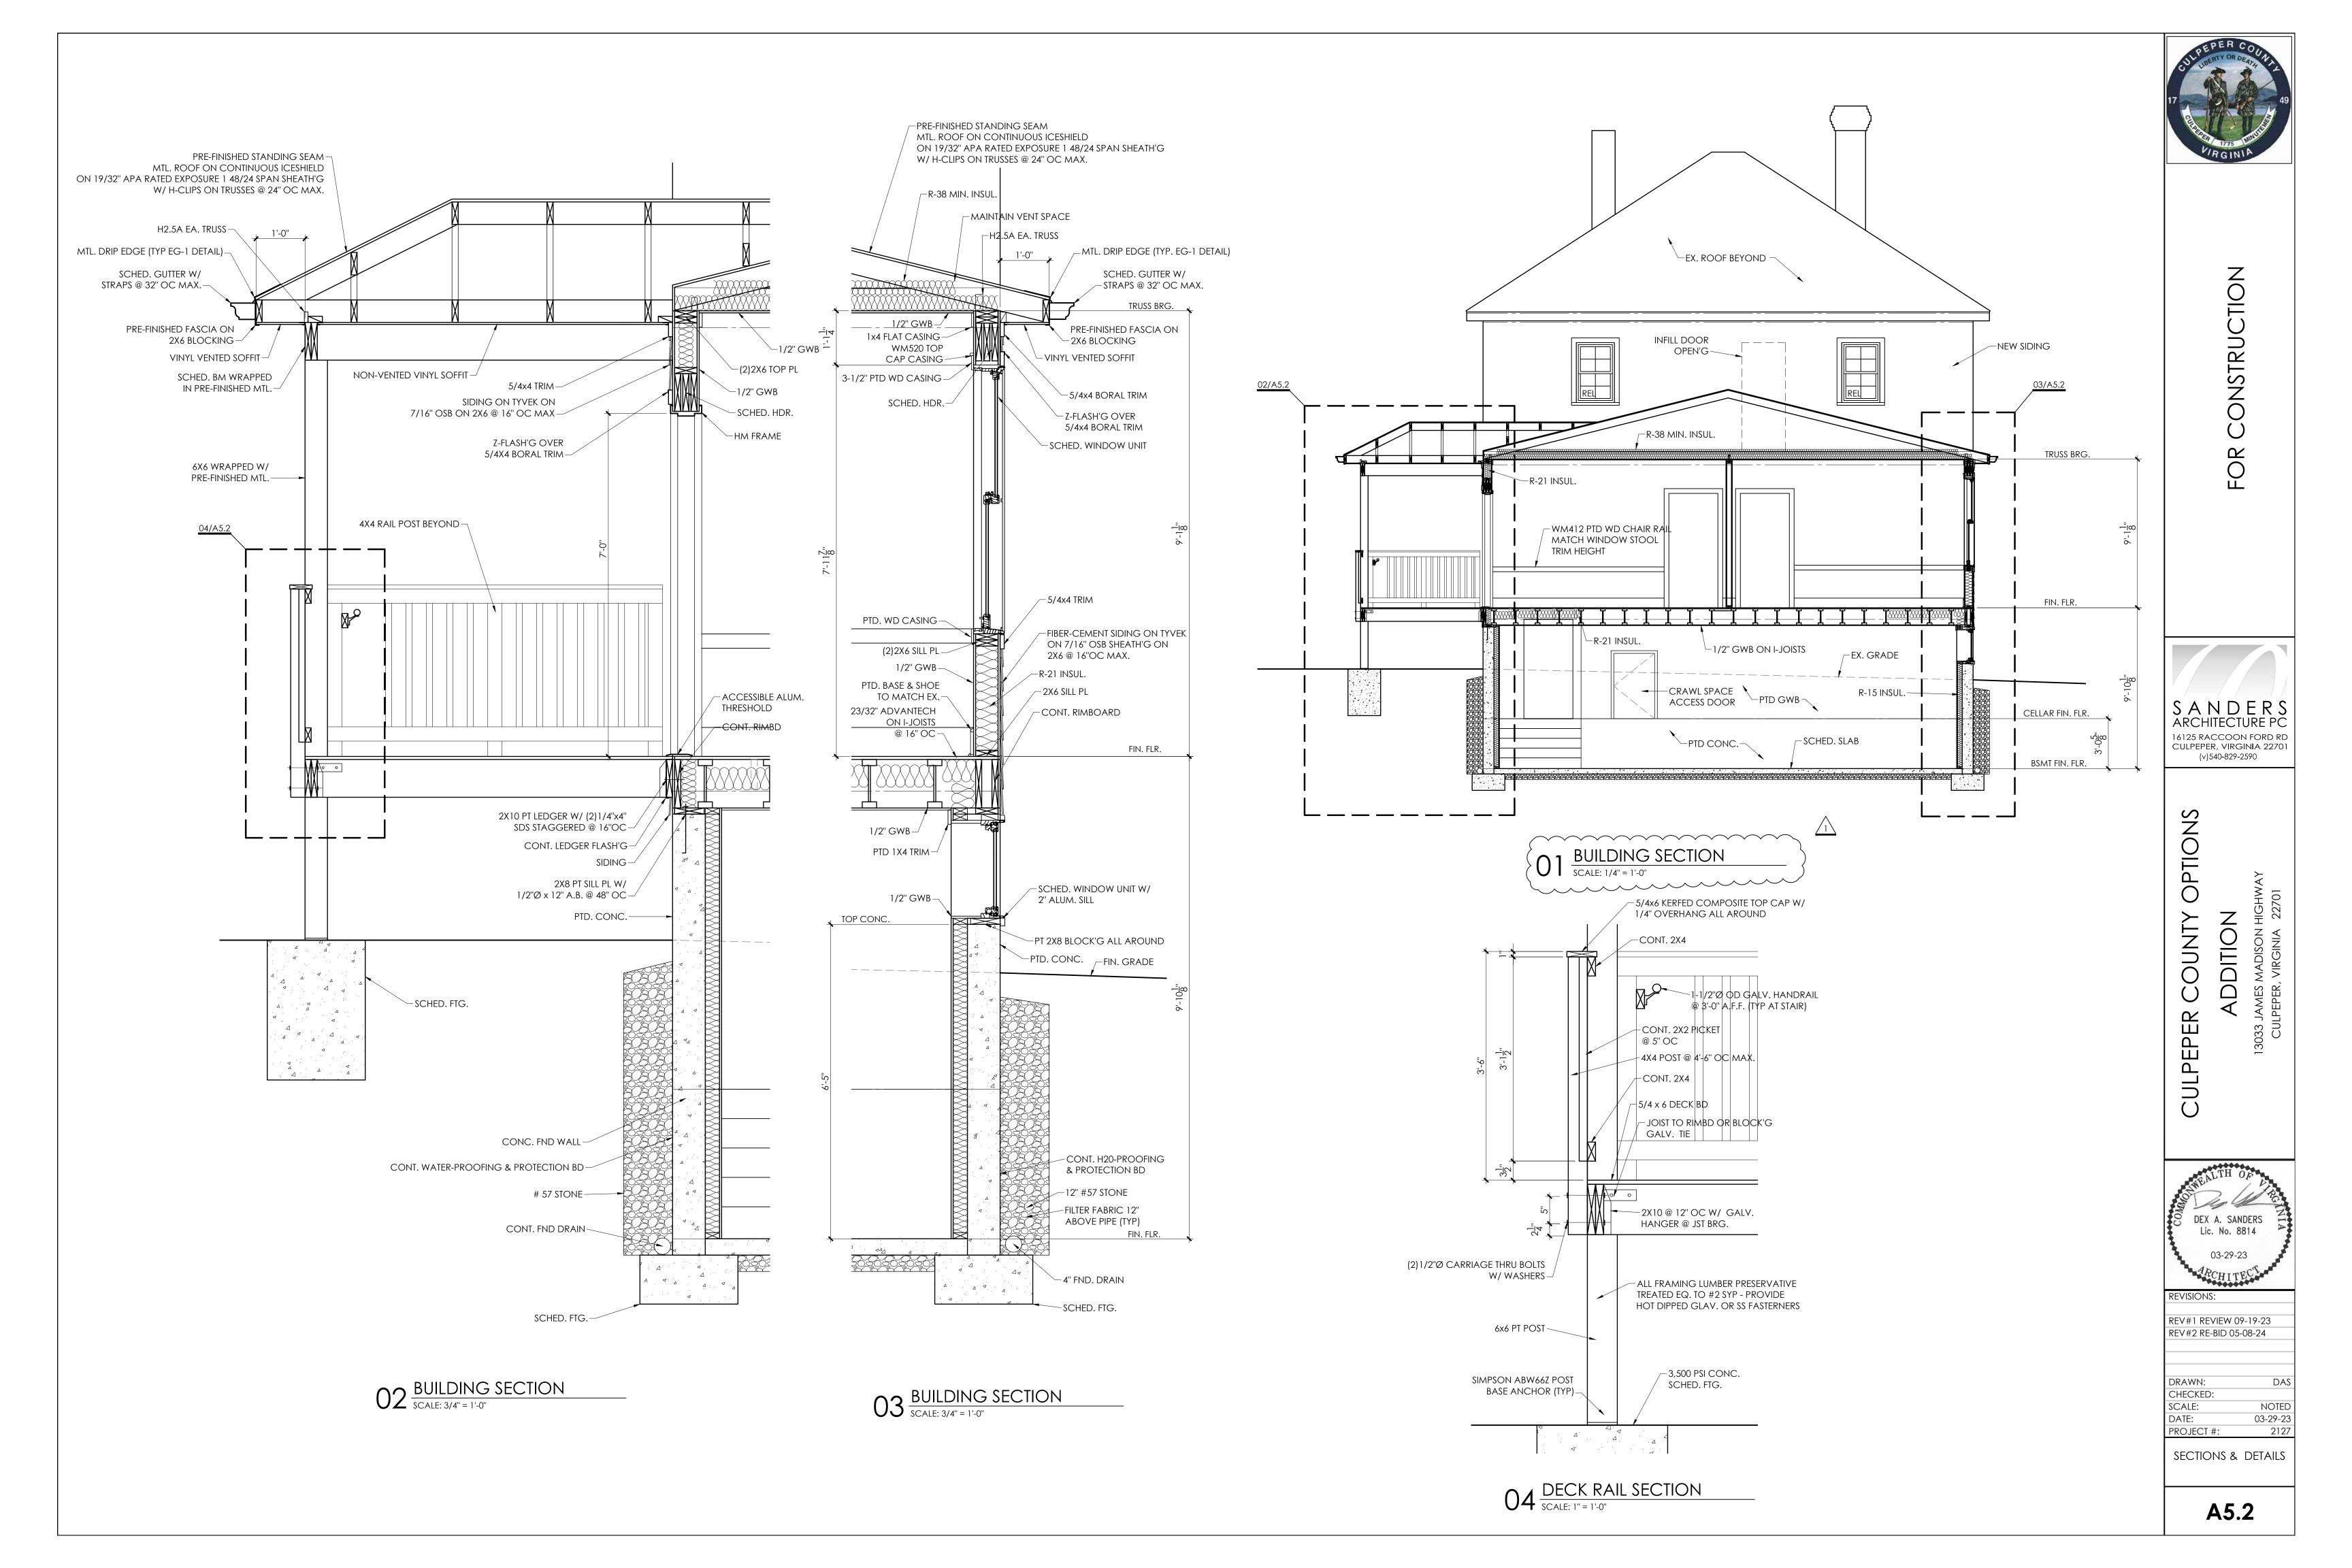COUNTY

REV#1 REVIEW 09-19-23 REV#2 RE-BID 05-08-24

DRAWN: CHECKED: SCALE: 03-29-23 PROJECT #: 2127

DETAILS DEPICTED THIS SHEET ARE BASED ON FABRAL SNAP-ON-SEAM

ROOFING AND ARE INTENDED TO SHOW ROOFING SPECIFIC DETAILS

ONLY. ROOFING INSTALLER SHALL PROVIDE DETAILS AND MATERIALS

NECESSARY AND RECOMMENDED BY THE APPROVED ROOFING MANUFACTURER TO PROVIDE THE INDICATED ROOFING WARRANTY.

ROOF DETAILS

A6.1

PANEL CUP (2) FASTENERS PER CUP INTO PLYWOOD DECK


— BUTYL TAPE SEALANT (ONLY REQ'D FOR SLOPES 2:12 OR LESS) - FASTENER, 12" O.C. - CLEAT - EAVE FLASHING -STRAP/HANGER PLYWOOD DECK, BY OTHERS — GUTTER APPROVED UNDERLAYMENT, TURN DOWN VERTICALLY 3" MIN. - FASCIA WRAP, OPTIONAL FASCIA BOARD, BY OTHERS

– FABRAL SNAP ON SEAM PANEL


– PANCAKE FASTENERS, 12" O.C.

– CAULK BETWEEN WEBS


TYPICAL GUTTER EAVE DETAIL (EG-1) SCALE: NONE

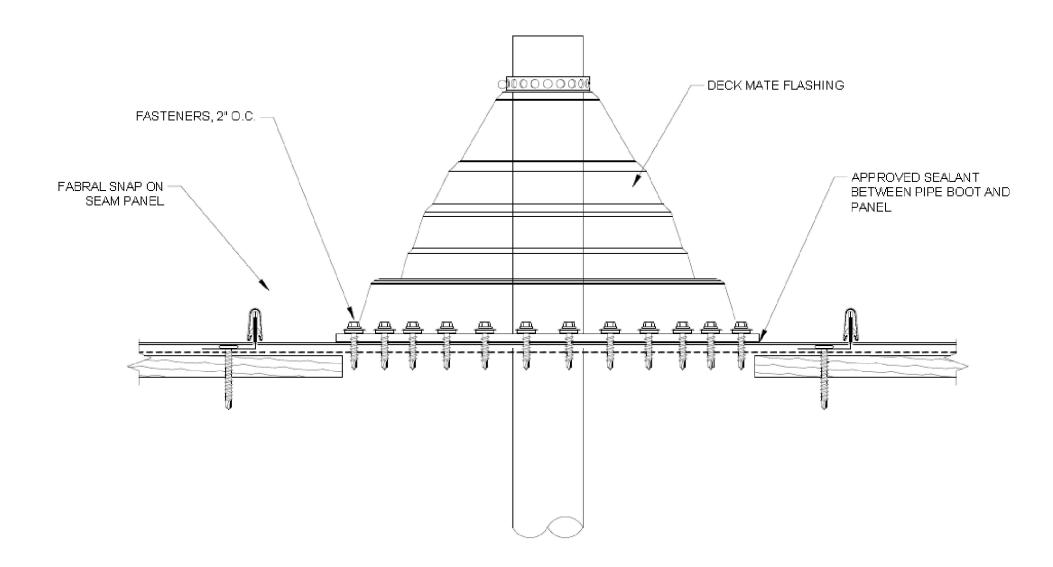



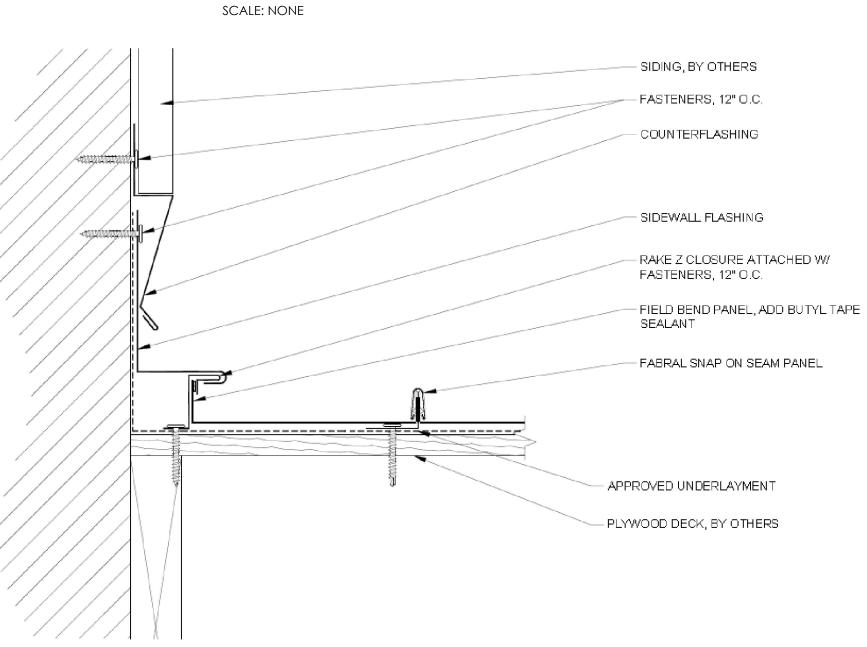

SIDEWALL DETAIL (SW-3) SCALE: NONE

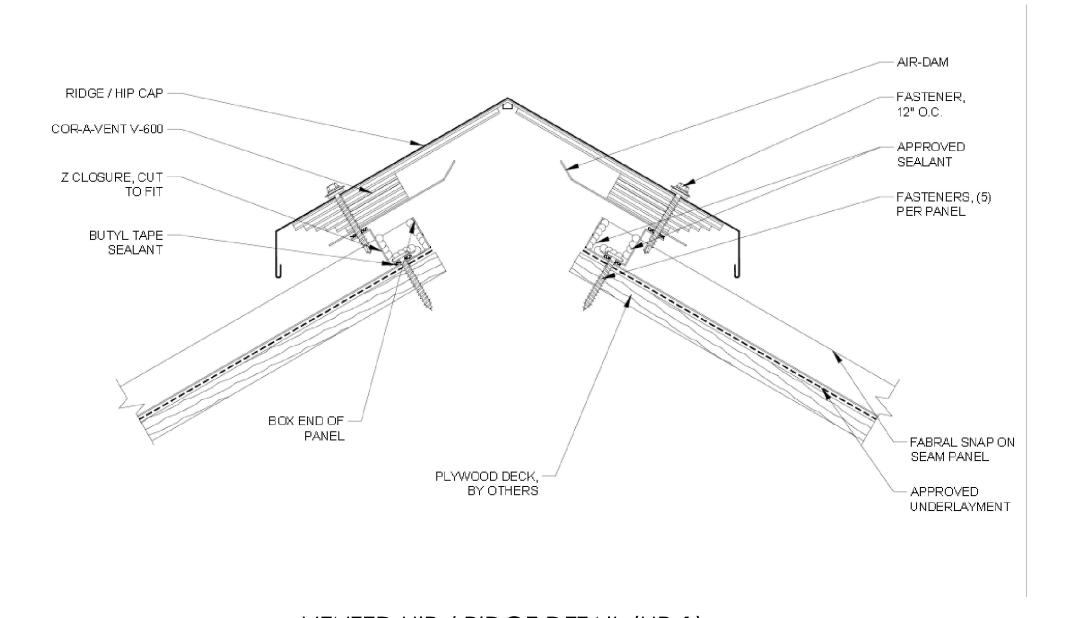

FIXED HIP / RIDGE DETAIL (HR-1)

SCALE: NONE

RIDGE / HIP CAP -

BUTYL TAPE -SEALANT

Z CLOSURE -CUT TO FIT.

BUTYL TAPE

SEALANT

BOX PANEL END

- FASTENER, 12" O.C.

– FASTENERS, (5) PER PANEL

- FABRAL SNAP ON

SEAM PANEL

APPROVED UNDERLAYMENT

– PLYWOOD DECK, BY OTHERS


APPROVED SEALANT


VENTED HIP / RIDGE DETAIL (HR-1) SCALE: NONE


CAULK BETWEEN-– FABRAL SNAP ON SEAM PANEL FILL PANEL HEM W/ -BUTYL SEALANT FASTENER, 12" O.C. APPROVED HT UNDERLAYMENT - VALLEY PAN APPROVED -UNDERLAYMENT PLYWOOD DECK, -BY OTHERS


> VALLEY DETAIL (V-2) SCALE: NONE

SCALE: 1/4" = 1'-0"

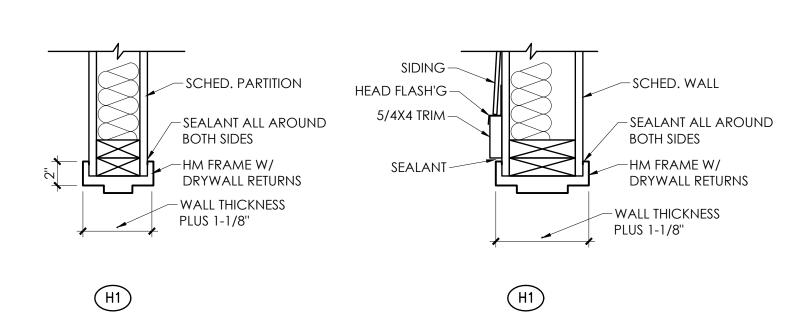

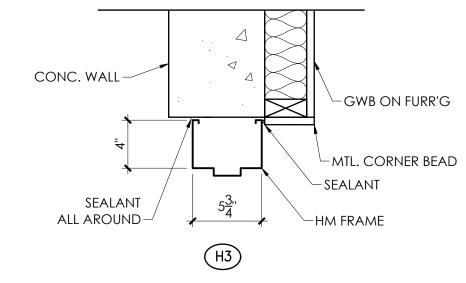

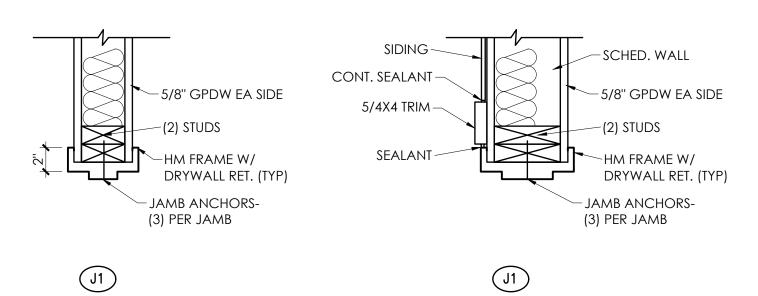

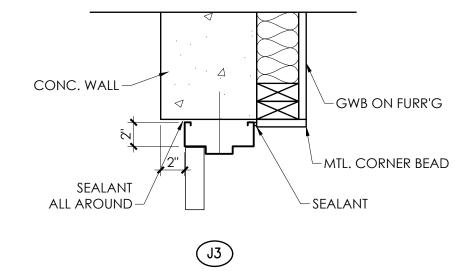

FRAME DETAILS SCALE: 1-1/2" = 1'-0"

	DOOR DOOR				FRAME					REMARKS			
	NO.	SIZE W X H X T	MAT'L	FIN	TYPE	LOUVER	MAT'L	FIN	DETAIL HEAD / JAMB	THRES	U.L. LABEL	HDW SET	
Щ	EX-1	3'-0"x7'-0"x1-3/4"	STEEL	PTD	Α	-	HM	PTD	H2/J2	ALUM.	-	-	LEVER LOCKSET, CLOSER
$\parallel = \parallel$	EX-2	3'-0"x7'-0"x1-3/4"	STEEL	PTD	Α	-	НМ	PTD	H3/J3	ALUM.	-	-	LEVER LOCKSET, CLOSER REPLACE DOOR TO REVERSE SWING, NEW WEATHERSTRIPPING
	B01	(2'-10"x6'-0"x1-3/4"	WD	PTD	С	-	WD	PTD	EXISTING	-	-	-	(REPLACE DOOR TO REVERSE SWING, NEW WEATHERSTRIPPING)
	101	3'-0''x7'-0''x1-3/4''	WD	PTD	В	3/4" UC	НМ	PTD	H1/J1	-	-	-	PASSAGE LATCHSET, NO CLOSER, KICKPL
	102	3'-0''x7'-0''x1-3/4"	WD	PTD	В	3/4" UC	НМ	PTD	H1/J1	-	-	-	PASSAGE LATCHSET, NO CLOSER, KICKPL
$ \cup $	103	3'-0''x7'-0''x1-3/4"	WD	PTD	С	-	НМ	PTD	H1/J1	-	-	-	PRIVACY LOCKSET, KICKPL, CLOSER
S	104	PR. 2'-0"x7'-0"x1-3/4"	WD	PTD	С	3/4" UC	НМ	PTD	Н1/Л1	-	-	-	LEVER PULL, FRICTION LATCH, NO CLOSER
O													

HARDWARE NOTES / TYPES

GENERAL NOTES:

1. U.N.O, ALL HINGED DOORS TO HAVE SURFACE MOUNTED CLOSERS. PROVIDE CLOSERS WITH HOLD OPEN FEATURES AT NON-RATED STORAGE DOORS.

- 2. ALL INTERIOR HARDWARE SATIN STAINLESS FINISH.
- 3. ALL LATCH SETS AND HANDLES TO BE MATCHING LEVER STYLE W/ FULL RETURN.
- 4. ALL INTERIOR DOORS TO HAVE MINIMUM GRADE 2 COMMERCIAL HARDWARE UNLESS OTHERWISE NOTED.
- 5. PROVIDE 10" KICKPLATES AT TOILET & CLASSROOM DOORS WHERE INDICATED.
- 6. EXTERIOR DOORS TO HAVE WEATHERSTRIPPING ALL AROUND W/ SILL SWEEPS. PROVIDE SILL SWEEPS WITH DRIPS AT OUTSWINGING STEEL DOORS WITHOUT OVERHANGS.
- 7. INSTALL ALL LOCKSETS AS SCHEDULED. KEY ALL EXTERIOR DOORS THE SAME. KEY ALL INTERIOR UTILITY DOORS ALIKE. KEY ALL DOORS TO A MASTER & GRANDMASTER KEY SYSTEM. COORDINATE W/ OWNER.
- 8. PROVIDE COMMERCIAL BRUSHED STAINLESS STEEL DOOR STOPS AT ALL DOORS FLOOR MOUNTED WHERE POSSIBLE OR WALL MOUNTED W/ FULL BLOCKING.

DOOR NOTES

- 1. ALL DOORS UP TO 7'-0" TALL TO HAVE 1 -1/2 PAIR HINGES. DOORS OVER 7'-0" TALL TO HAVE 2 PAIR HINGES. PROVIDE (2) PAIR HINGES FOR 4'-0" WIDE DOORS.
- 2. UNDERCUT DOORS AS REQUIRED FOR EASE OF OPERATION. ALL DOORS SHALL HANG 1/8" ABOVE FINISHED FLOOR/THRESHOLD EXCEPT DOORS SCHEDULED TO BE UNDERCUT OR SPECIAL ACOUSTIC DOORS.
- 3. WOOD DOORS: ALL DOORS TO BE REINFORCED FOR CLOSERS. PROVIDE MATCHING WOOD TRIM AT LITES. INTERIOR GLASS TO BE $\frac{1}{4}$ " - SAFETY AND / OR FIRE RATED WHERE REQUIRED
- 4. PROVIDE (3) SILENCERS TYP. AT EACH INTERIOR DOOR AT HOLLOW METAIL FRAMES ON THE LATCHING SIDE.

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OPTIONS COUNTY CULPEPER


REVISIONS:

REV#1 REVIEW 09-19-23 REV#2 RE-BID 05-08-24

DRAWN: CHECKED: 03-29-23 PROJECT #: 2127

ELEVATIONS

A8.1

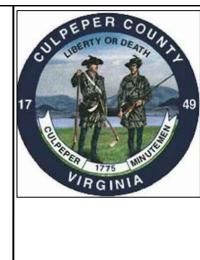



S A N D E R S ARCHITECTURE PC 16125 RACCOON FORD RD CULPEPER, VIRGINIA 22701 (v)540-829-2590

OPTIONS

COUNTY

FR

EP

ADDITION
3033 JAMES MADISON HIGHWA

DEX A. SANDERS
Lic. No. 8814

03-29-23


REVISIONS:

REV#1 REVIEW 09-19-23 REV#2 RE-BID 05-08-24

DRAWN: DAS
CHECKED:
SCALE: NOTED
DATE: 03-29-23
PROJECT #: 2127


MECHANICAL PLAN

M1.1

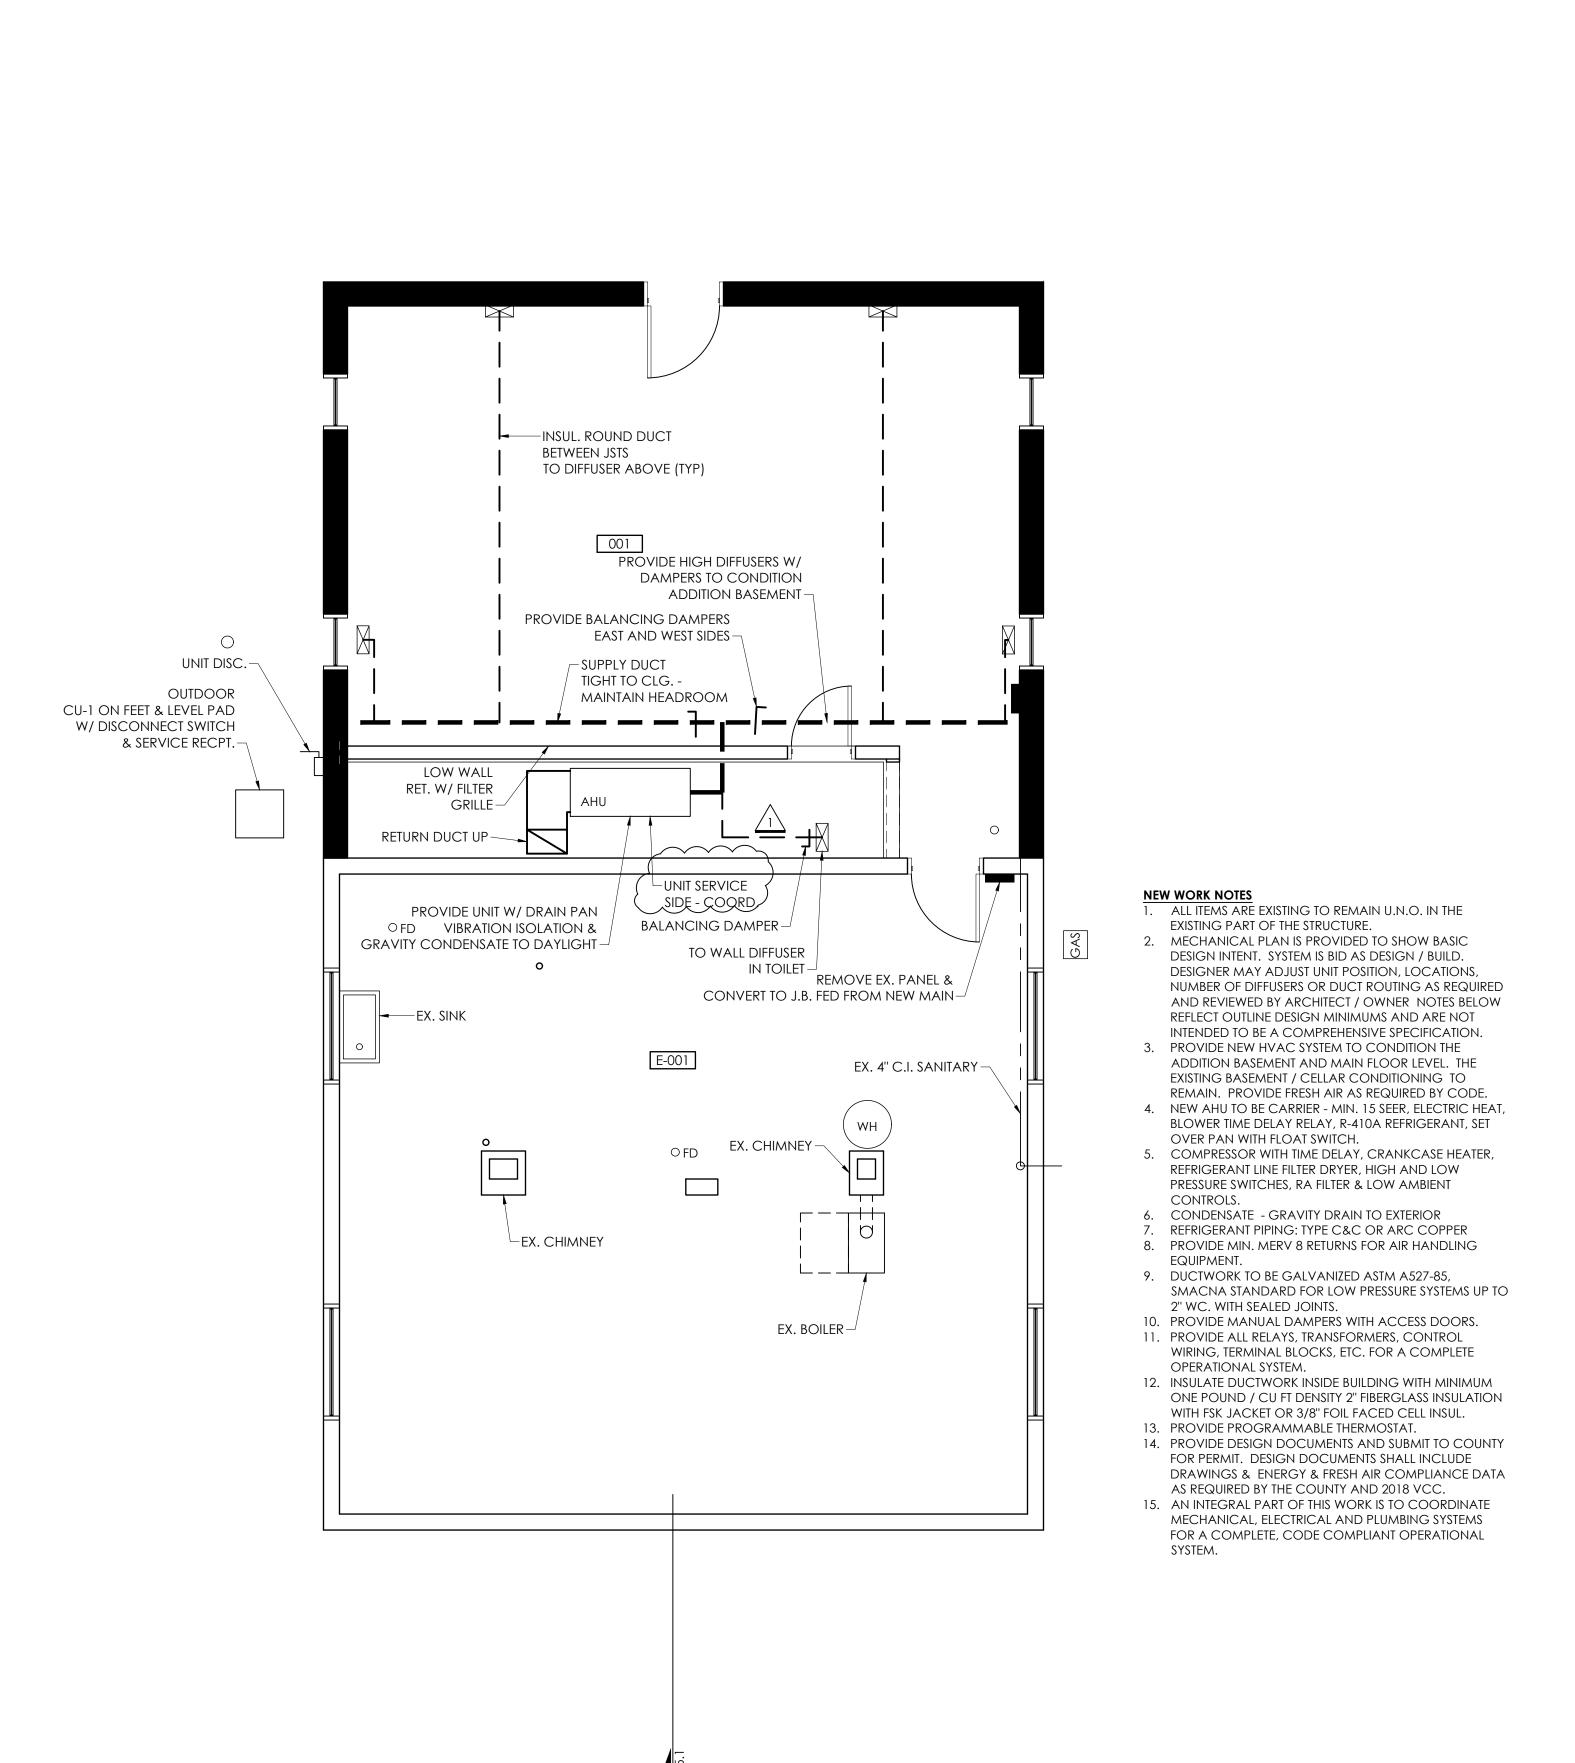


BASEMENT FLOOR MECHANICAL PLAN

SCALE: 1/4" = 1'-0"

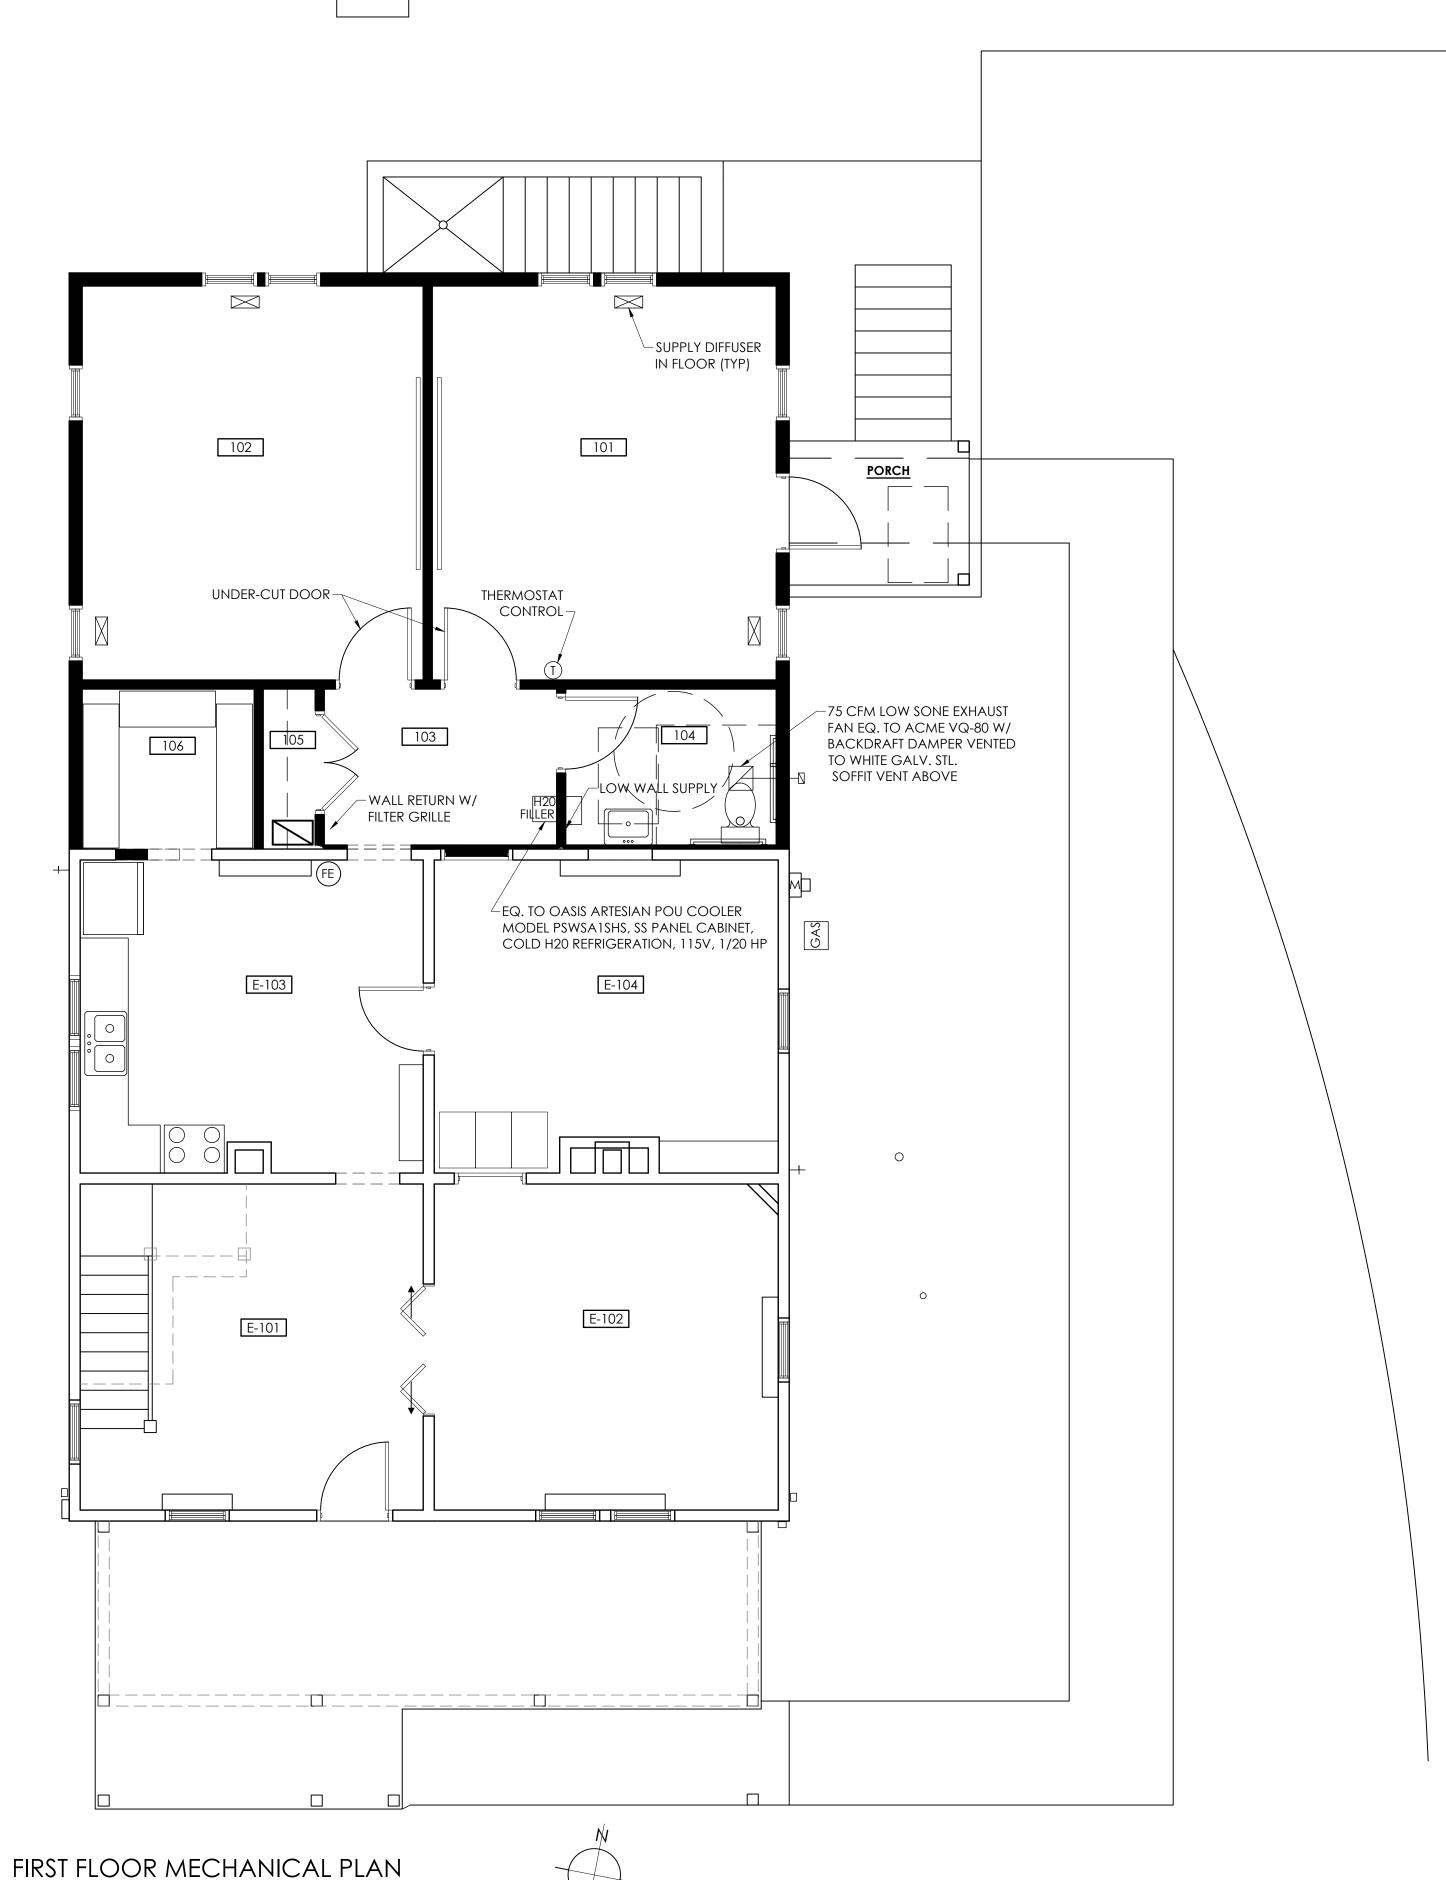

SCALE: 1/4" = 1'-0"

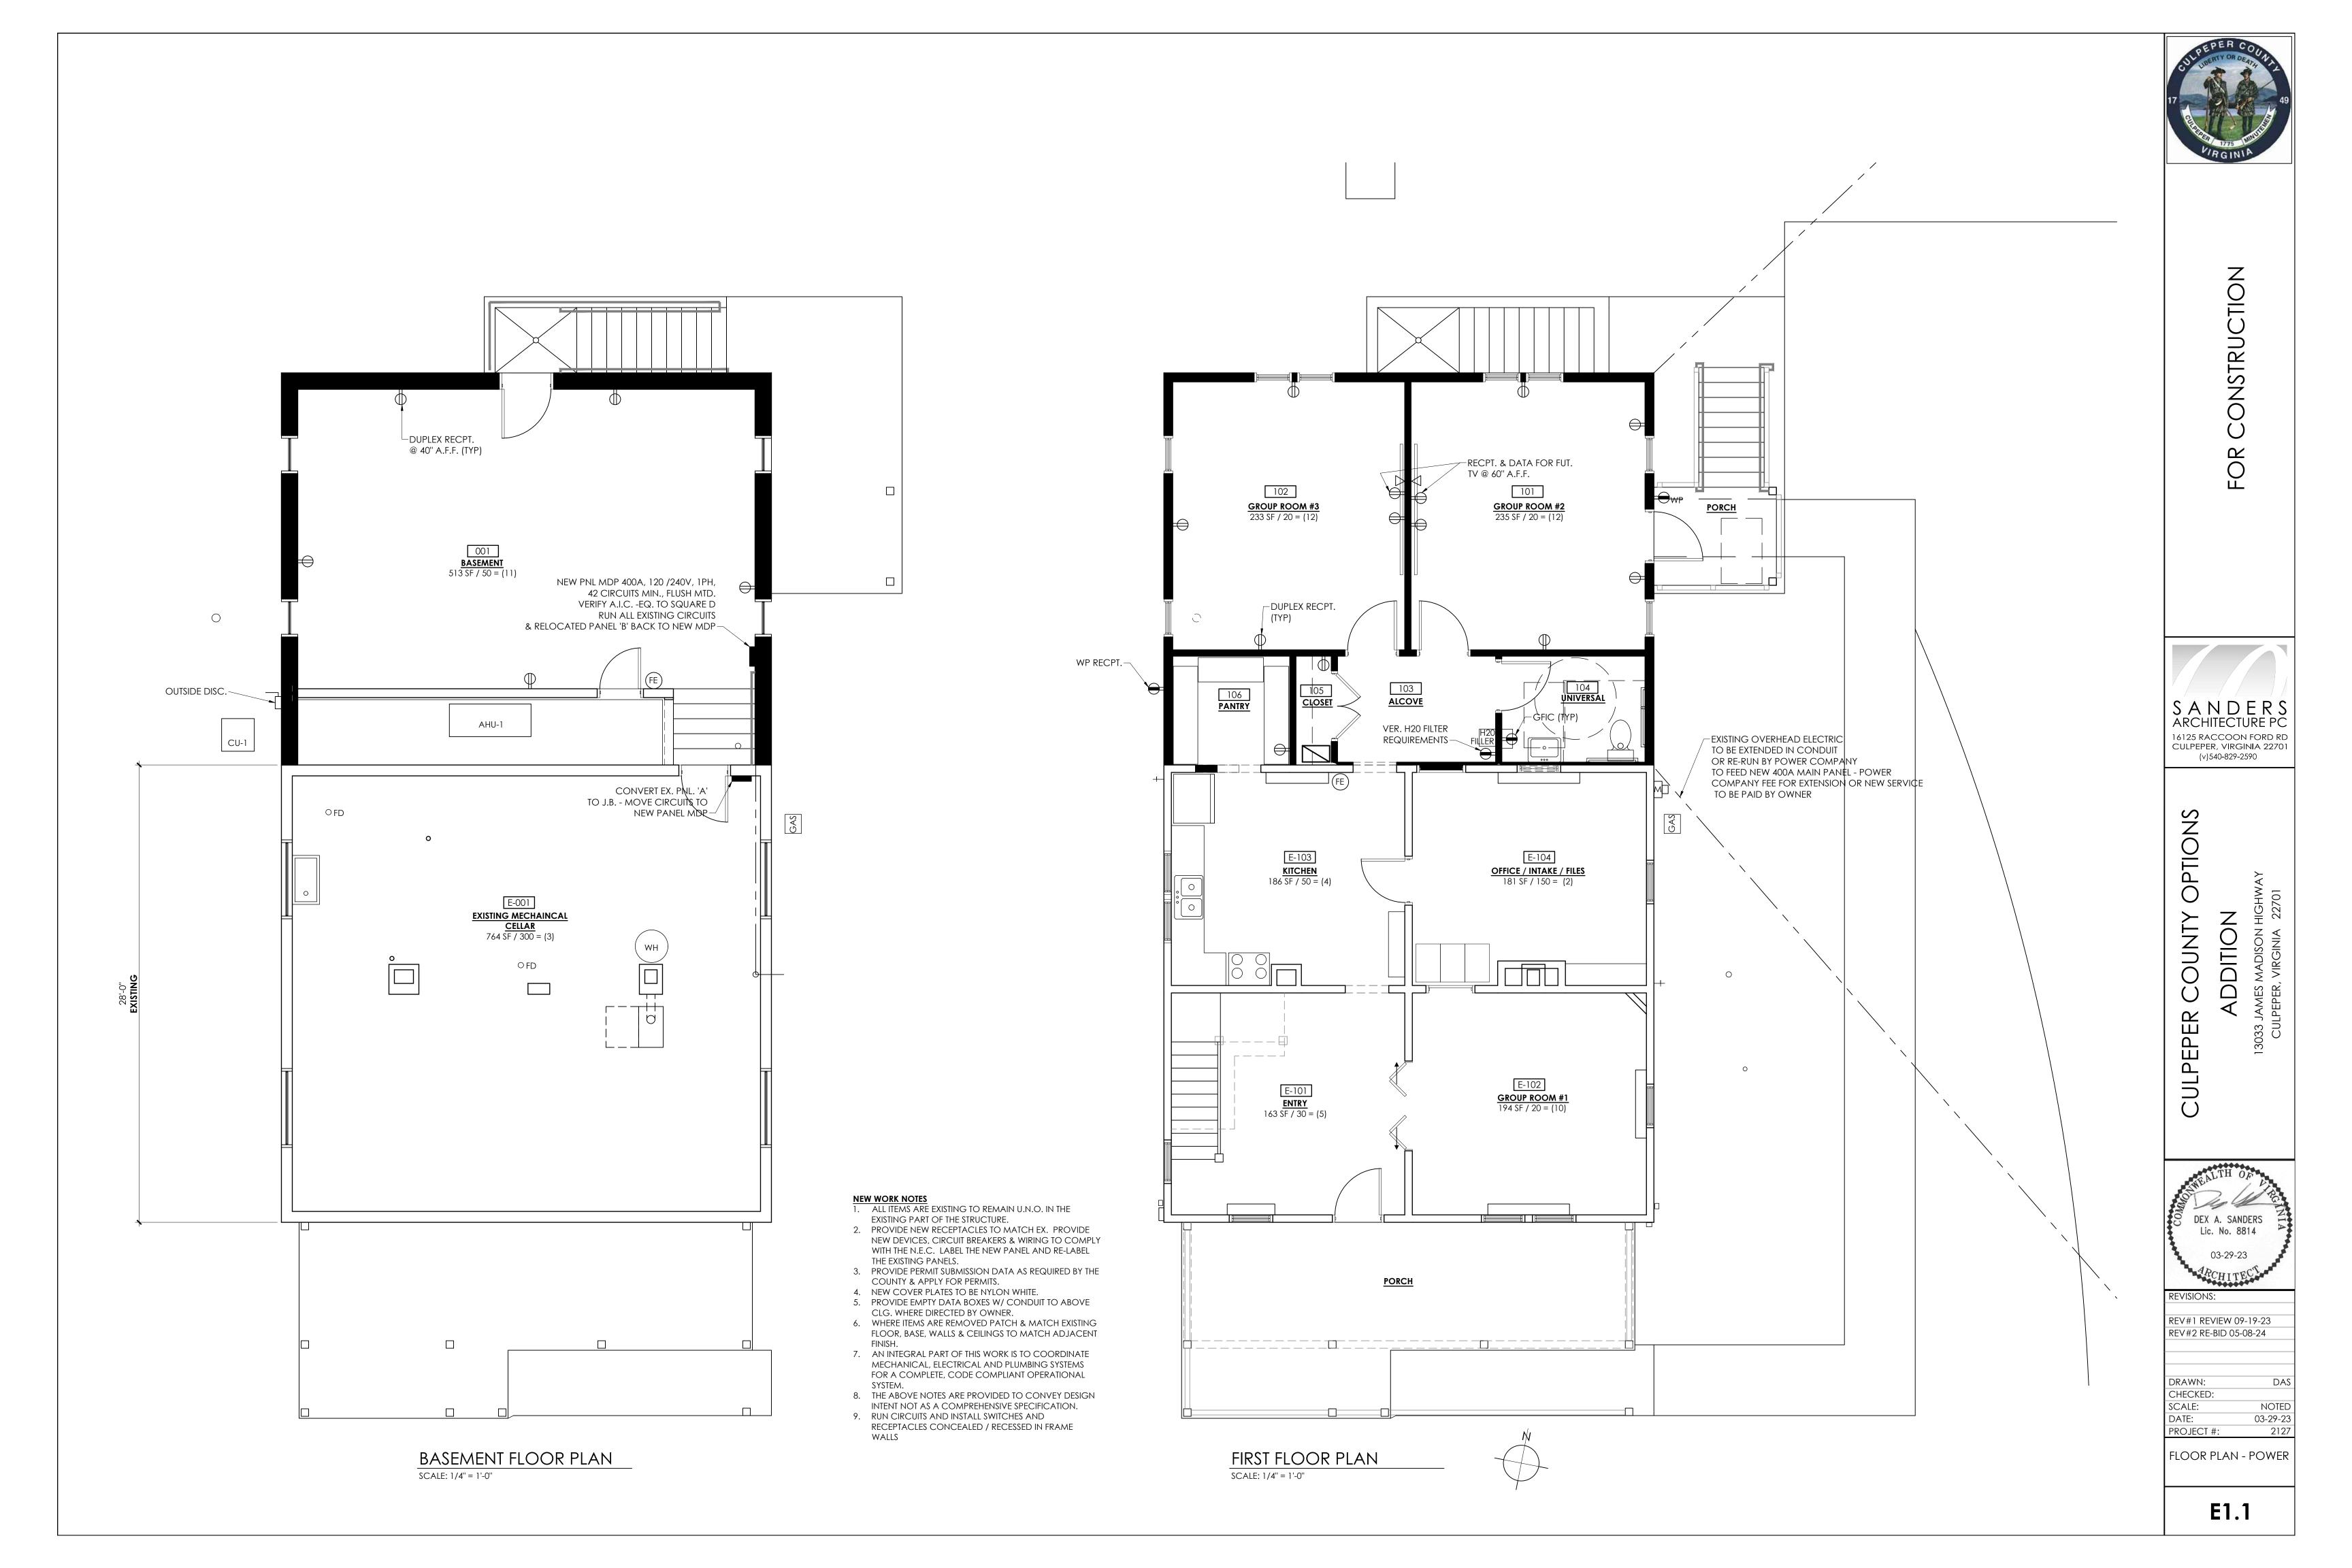


REV#1 REVIEW 09-19-23 REV#2 RE-BID 05-08-24

DRAWN: DAS
CHECKED:
SCALE: NOTED
DATE: 03-29-23
PROJECT #: 2127

CEILING / LIGHTING PLAN

E2.1

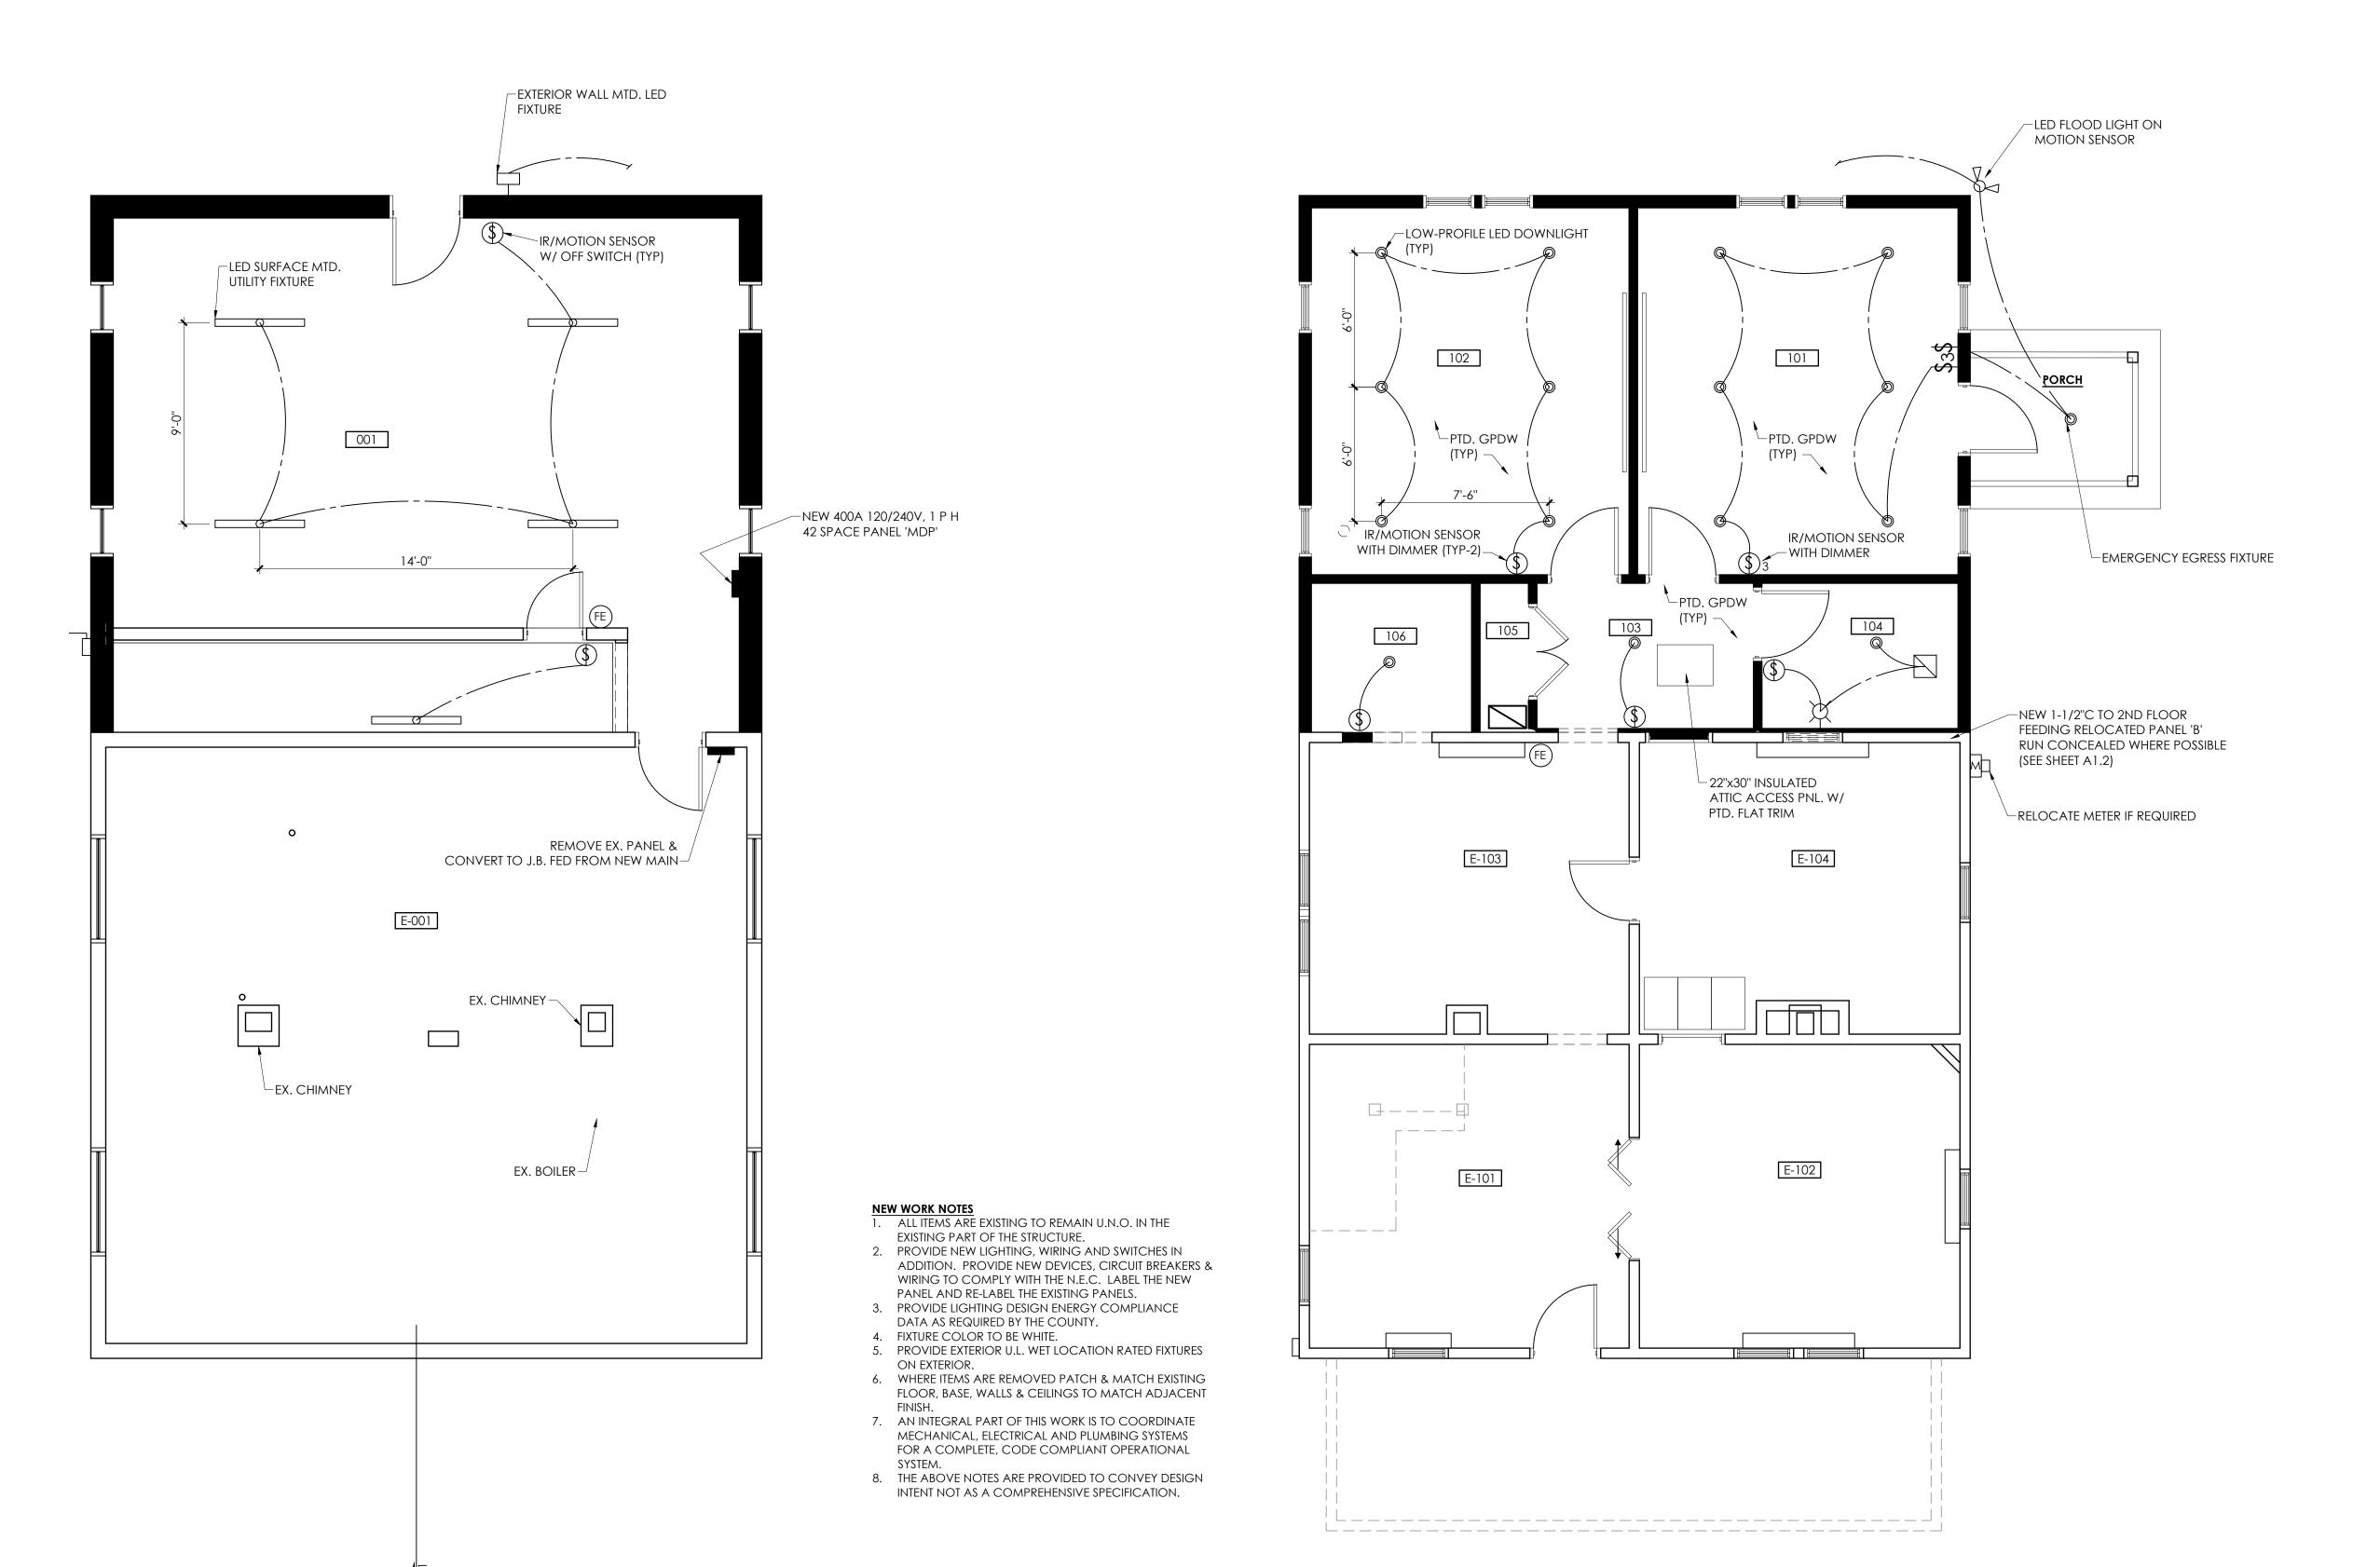

BASEMENT FLOOR CEILING / LIGHTING PLAN

SCALE: 1/4" = 1'-0"

FIRST FLOOR CEILING / LIGHTING PLAN

SCALE: 1/4" = 1'-0"